January 10, 2022

## Mountlake Terrace Recreation and Parks Department

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#### Project Site


22231 56th Ave W. Mountlake Terrace, WA 98043

#### Legal Description

A PORTION OF THE NE QUARTER, OF THE SW QUARTER OF SECTION 28, TOWNSHIP 27 N, RANGE 04 E, W.M, CITY OF MOUNTLAKE TERRACE, COUNTY OF SNOHOMISH, STATE OF WASHINGTON

#### Parcel Information

Snohomish County Tax Parcel #: 52000010-0200

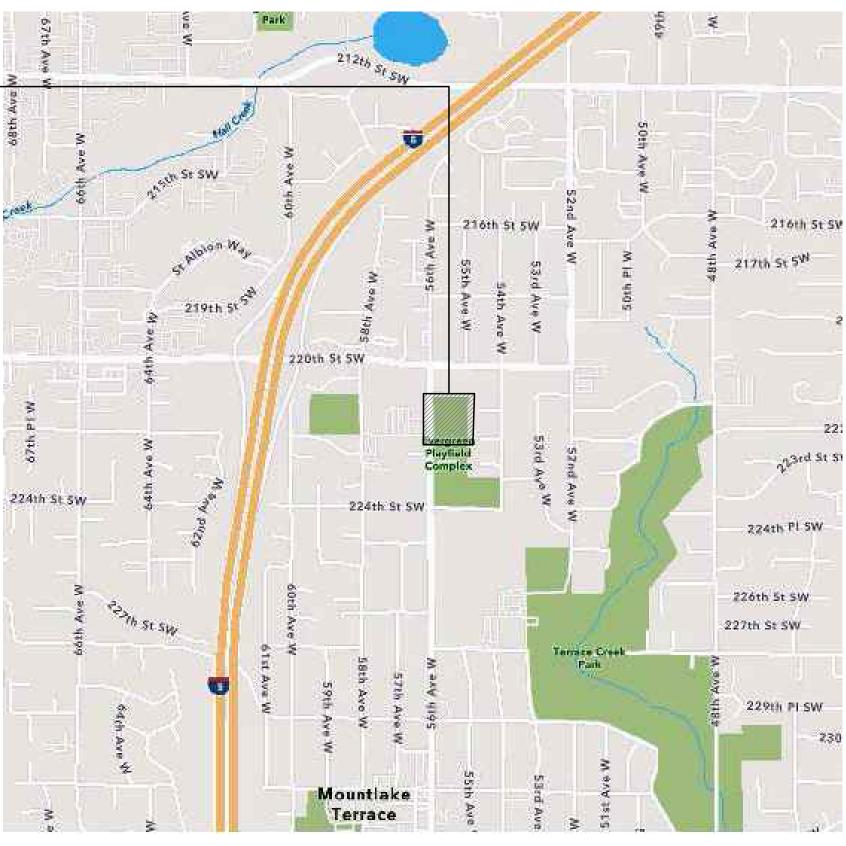

# Vicinity Map



#### **Abbreviations**

Site Details


Drainage Details

ABN	ABANDON	F&G	FRAME & GRADE	OC	ON CENTER
AC	ASPHALTIC CONCRETE	FDN	FOUNDATION	OD	OUTSIDE DIAMETER
ADD	ADDITIVE	FFE	FINISH FLOOR ELEVATION	OR	OWNER'S REPRESENTATIVE
ALT	ALTERNATE	FG	FINISHED GRADE	PC	POINT OF CURVATURE
ALUM	ALUMINUM	FIN GR	FINISH GRADE	PCC	PORTLAND CEMENT CONCRETE
APPROX	APPROXIMATELY	FL	FLANGE	P.E.	PROFESSIONAL ENGINEER
A.T.	ALL-THREAD	FM	FORCE MAIN	PERF	PERFORATED
<b>@</b>	AT	FT	FOOT, FEET	PERIM	PERIMETER
BLKG	BLOCKING	FTG	FOOTING	PI	POINT OF INTERSECTION
ВМ	BENCH MARK	GA	GAUGE	PLT	PLATE
BMP	BEST MANAGEMENT PRATICES	GAL	GALLON	PLYWD	PLYWOOD
BOC	BOTTOM OF CURB	GALV	GALVANIZED	POLY	POLYETHYLENE
BW	BOTTOM OF WALL	GN	GROUND	PRO	PROPOSED
CB	CARRIAGE BOLT	GPM	GALS. PER MINUTE	PRV	PRESSURE REDUCING VALVE
CB	CATCH BASIN	GV	GATE VALVE	PSE	PUGET SOUND ENERGY
CF	CUBIC FOOT	GW	SANDY GRAVEL	PSI	POUNDS PER SQUARE INCH
CIE	COLLECTOR INVERT ELEVATION	HL	HELICAL	PT PT	POINT OF TANGENCY
CL	CLASS	HMA	HOT MIX ASPHALT	PŤ	PRESSURE TREATED
CLR	CLEARING, CLEARANCE	HP	HIGH POINT	PVC	POLYVINYL CHLORIDE
CMP	CORRUGATED METAL PIPE	нт	HEIGHT	PVC	POINT OF VERTICAL CURVATURE
CO	CLEANOUT	HZ	HORIZONTAL	PVI	POINT OF VERTICAL INTERSECTION
CO	CONTRACTING OFFICER	ID	INSIDE DIAMETER	PVMT	
CONT	CONTINUOUS	I.E.	INVERT ELEVATION	PVT	PAVEMENT POINT OF VERTICAL TANGENCY
CONC	CONCRETE	IN	INCH	R	
CORR	CORRUGATED	INV	INVERT ELEVATION		RADIUS
CP	CENTER POINT	IRR	IRRIGATION	REQ'D	REQUIRED
CS	COUNTERSINK	JT	JOINT	RP	RADIUS POINT
CSBC	CRUSHED SURFACING BASE COURSE	L	LEFT, LONG	S S	SLOPE (FT/FT)
CSTC	CRUSHED SURFACING BASE COURSE CRUSHED SURFACING TOP COURSE		LAG BOLT		SOUTH
CY		LB		SCH	SCHEDULE
	CUBIC YARD	LF	LINEAL FOOT/FEET	SD	STORM DRAIN
DEMO	DEMOLISH	LP	LOW POINT	SEC	SECTION
DET	DETAIL PON	LS	LAG SCREW	SF	SQUARE FEET
DI	DUCTILE IRON	MAT'L	MATERIAL	SHLDR	SHOULDER
DIA	DIAMETER	MAX	MAXIMUM	SIM	SIMILAR
DTL	DETAIL	MB	MACHINE BOLT	SM	SILTY SAND
DWG	DRAWING	MIL	1/1000th INCH	SP'D	SPACED
E	EAST	MIN	MINIMUM	SQ	SQUARE
EA	EACH	MJ	MECHANICAL JOINT	SS	SANITARY SEWER
EL, ELEV	ELEVATION	MPOC	MID-POINT OF CURVE	STD	STANDARD
ELEC	ELECTRICAL EDGE OF BANGUENT	N	NORTH	STA	STATION
EOP	EDGE OF PAVEMENT	NIC	NOT IN CONTRACT	STL	STEEL
EQ	EQUAL	NO.	NUMBER	SY	SQUARE YARD
EQ SP	EQUAL SPACING	NOM	NOMINAL	TC	TOP OF CONCRETE
EX, EXIST	EXISTING	NTS	NOT TO SCALE	THK	THICK
				••••	

TOC TOP OF CURB
TOS TOP OF SLAB
TW TOP OF WALL
TYP TYPICAL
UNO UNLESS NOTED OTHERWISE
VC VERTICAL CURVE
VERT VERTICAL
W/ WITH
W/IN WITHIN
W/O WITHOUT
WD WIDTH
WM WATER MAIN
WSDOT WASHINGTON STATE DEPARTMENT OF
TRANSPORTATION
WWM WELDED WIRE MESH

THIS DRAWING SET REFLECTS ON-SITE CHANGES FROM CONTRACTOR-PROVIDED AS-BUILT DRAWINGS, AND DESIGN CHANGE DRAWINGS DEVELOPED DURING THE CONSTRUCTION PERIOD

THE LOCATIONS AND DIMENSIONS OF ELEMENTS PROVIDED HEREIN THAT WERE CHANGED FROM THE CONSTRUCTION SET OF DRAWINGS, ARE HIGHLIGHTED BY CLOUDS.

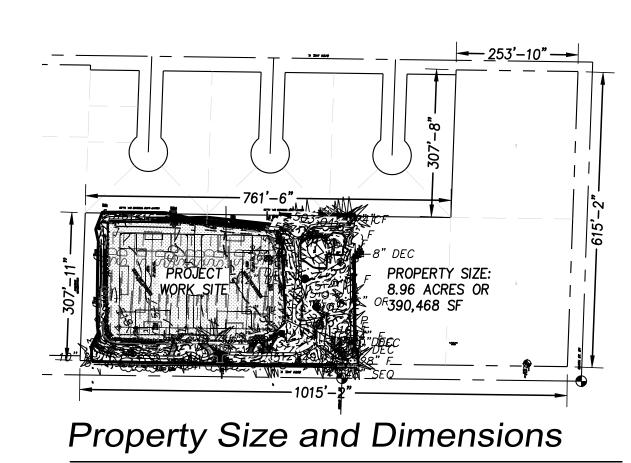

Scale: 1"=200'

#### **Grading General Notes**

- 1. ALL WORK AND MATERIALS SHALL BE IN ACCORDANCE WITH THE "STANDARD SPECIFICATIONS FOR ROAD, BRIDGE, AND MUNICIPAL CONSTRUCTION," WASHINGTON STATE DEPARTMENT OF TRANSPORTATION, CURRENT EDITION, TOGETHER WITH THE LATEST EDITION OF THE CITY OF MOUNTLAKE TERRACE ENGINEERING STANDARDS.
- 2. AN APPROVED COPY OF THESE PLANS MUST BE ON SITE WHENEVER CONSTRUCTION IS IN PROGRESS.
- 3. IT SHALL BE THE SOLE RESPONSIBILITY OF THE CONTRACTOR TO OBTAIN STREET USE AND ANY OTHER RELATED PERMITS PRIOR TO ANY CONSTRUCTION ACTIVITY IN CITY RIGHT—OF—WAY.
- 4. PRIOR TO ANY CONSTRUCTION ACTIVITY, THE CITY OF MOUNTLAKE TERRACE ENGINEERING DEPARTMENT (425-776-1161) MUST BE CONTACTED FOR A PRECONSTRUCTION MEETING.
- 5. ALL LOCATIONS OF EXISTING UTILITIES SHOWN HEREON HAVE BEEN ESTABLISHED BY FIELD SURVEY OR OBTAINED FROM AVAILABLE RECORDS AND SHOULD THEREFORE BE CONSIDERED APPROXIMATE ONLY AND NOT NECESSARILY COMPLETE. IT IS THE SOLE RESPONSIBILITY OF THE CONTRACTOR TO INDEPENDENTLY VERIFY THE ACCURACY OF ALL UTILITY LOCATIONS SHOWN, AND TO FURTHER DISCOVER AND AVOID ANY OTHER UTILITIES NOT SHOWN HEREON WHICH MAY BE AFFECTED BY THE IMPLEMENTATION OF THIS PLAN. THE CONTRACTOR SHALL CONTACT THE UTILITIES UNDERGROUND LOCATION SERVICE (1-800-424-5555) PRIOR TO CONSTRUCTION. THE OWNER OR HIS REPRESENTATIVE SHALL BE IMMEDIATELY CONTACTED IF A UTILITY CONFLICT EXISTS.
- 6. THE TEMPORARY EROSION/SEDIMENTATION CONTROL FACILITIES SHALL BE CONSTRUCTED PRIOR TO ANY GRADING OR EXTENSIVE LAND CLEARING IN ACCORDANCE WITH THE APPROVED TEMPORARY EROSION/SEDIMENTATION CONTROL PLANS. THESE FACILITIES MUST BE SATISFACTORILY MAINTAINED UNTIL CONSTRUCTION AND LANDSCAPING IS COMPLETED AND THE POTENTIAL FOR ON—SITE EROSION HAS PASSED.
- 7. ALL ROCKERIES SHALL CONFORM WITH THE CITY OF MOUNTLAKE TERRACE STANDARD PLAN NO. 601. A FOUR (4) INCH MINIMUM DIAMETER PVC PERFORATED PIPE, OR EQUAL, WILL BE INSTALLED BEHIND THE ROCKERY AT OR BELOW THE BOTTOM OF THE LOWEST ROCK IN THE ROCKERY BACKFILL (SEE DETAIL). THIS PIPE SHALL BE DIRECTLY CONNECTED TO THE UNDERGROUND STORM DRAINAGE SYSTEM WITH NON-PERFORATED PVC PIPE OR AS OTHERWISE SHOWN ON THE PLANS.
- 8. ALL EARTHWORK UNDER PAVING SHALL BE COMPACTED TO MINIMUM 95% DRY OPTIMUM DENSITY PER ASTM D-1557, OR LATEST REVISION, (MODIFIED PROCTOR).
- 9. UNLESS OTHERWISE NOTED, ALL ELEVATIONS SHOWN IN PAVED AREAS ON THE PLANS ARE TOP OF PAVING.
- 10. SEE TEMPORARY EROSION/SEDIMENTATION CONTROL GENERAL NOTES FOR ACCEPTABLE EROSION CONTROL MEASURES UPON COMPLETION OF GRADING.
- 11. MAJOR EXPOSED GRADED SLOPES SHOWN ON THESE PLANS SHALL BE PROTECTED WITH PLASTIC SHEETS UNTIL SUCH TIME AS THE VEGETATIVE COVER HAS BEEN ESTABLISHED SUFFICIENTLY TO ELIMINATE EROSION.
- 12. GRADES SHOWN REPRESENT THE ENGINEER'S ESTIMATE OF APPROXIMATE MINIMUM EARTHWORK, PRESERVATION OF THE MAXIMUM NUMBER OF EXISTING TREES, AND OTHER GRADING/SOIL CONSIDERATIONS. THE CONTRACTOR MAY ALTER THE GRADES SHOWN TO BETTER ACHIEVE THESE RESULTS, PROVIDED THAT ANY ALTERATION IS SUBJECT TO THE PRIOR APPROVAL IN WRITING BY THE ENGINEER, OWNER, AND THE APPROPRIATE DEPARTMENTS OF THE CITY OF MOUNTLAKE TERRACE.
- 13. THE SITE WORK IMPROVEMENTS SHALL BE CONSTRUCTED ACCORDING TO THE APPROVED PLANS WHICH ARE ON FILE IN THE ENGINEERING DEPARTMENT. ANY DEVIATION FROM THE APPROVED PLANS WILL REQUIRE APPROVAL FROM THE PROPER AGENCY. GRADING GENERAL NOTES
- 14. THE CONTRACTOR SHALL KEEP PARKING LOTS AND STREETS CLEAN AT ALL TIMES BY SWEEPING. WASHING OF ANY STREETS, PARKING LOTS OR DRIVEWAYS TO REMOVE CONSTRUCTION RELATED DIRT IS STRICTLY FORBIDDEN AND SUBJECT TO FINES.
- 15. ALL PARKING AND DRIVEWAY AREAS TO HAVE POSITIVE DRAINAGE TO COLLECTION, CONVEYANCE SYSTEMS OR OVERLAND SHEET DRAIN AREAS AT A MINIMUM OF ONE PERCENT SLOPE. PLAN DETAILS SHALL NOT SUPERSEDE THIS REQUIREMENT.
- 16. OPEN-CUT ROAD CROSSINGS FOR UTILITY TRENCHES ON EXISTING TRAVELED ROADWAYS SHALL BE BACKFILLED IN ACCORDANCE WITH CITY OF MOUNTLAKE TERRACE STANDARD PLAN NO. 112 AND MECHANICALLY COMPACTED. CUTS INTO THE EXISTING ASPHALT SHALL BE NEAT LINE CUT WITH SAW IN A CONTINUOUS LINE. A TEMPORARY COLD MIX PATCH MUST BE PLACED IMMEDIATELY AFTER BACKFILL AND COMPACTION. A PERMANENT HOT MIX PATCH SHALL BE PLACED WITHIN 30 DAYS AND SHALL BE THE THICKNESS OF THE ORIGINAL ASPHALT, OR THREE (3) INCHES, WHICHEVER IS GREATER. A 2"THICK ATB TEMPORARY PATCH MAY BE USED IN LIEU OF A COLD MIX PATCH.
- 17. EXTRUDED CEMENT CONCRETE CURBS AROUND ASPHALT EDGES SHALL BE CONSTRUCTED IN ACCORDANCE WITH CITY OF MOUNTLAKE TERRACE STANDARD PLAN NO. 109.
- 18. EXISTING VEGETATION SHALL BE RETAINED IN AREAS WHERE GRADING IS UNNECESSARY.
- 19. ALL RECOMMENDATIONS MADE BY THE GEOTECHNICAL ENGINEER(S) UP TO NOW, OR AT ANY TIME IN THE FUTURE, INCLUDING, BUT NOT LIMITED TO RECOMMENDATIONS FOR CONSTRUCTION TECHNIQUES, CONSTRUCTION SCHEDULE, AND CONTROL OF STORM WATER RUNOFF THROUGHOUT THE PROJECT COMPLETION SHALL BE FOLLOWED. WHOMEVER CONSTRUCTS SITE IMPROVEMENTS SHALL RETAINED A LICENSED GEOTECHNICAL ENGINEER TO OVERSEE AND ADVISE DURING CONSTRUCTION AND SITE GRADING TO ASSURE THAT ALL GEOTECHNICAL RECOMMENDATIONS ARE ADHERED TO. THE APPLICANT IS RESPONSIBLE FOR PROVIDING SPECIAL INSPECTION AND COMPACTION CERTIFICATION FOR THE BUILDING PADS, UTILITY TRENCHES, RETAINING WALLS AND DETENTION VAULT/TANK BACKFILL.

#### **Storm Drainage General Notes**

- 1. ALL WORK AND MATERIALS SHALL BE IN ACCORDANCE WITH THE "STANDARD SPECIFICATIONS FOR ROAD, BRIDGE, AND MUNICIPAL CONSTRUCTION," WASHINGTON STATE DEPARTMENT OF TRANSPORTATION, CURRENT EDITION, TOGETHER WITH THE LATEST EDITION OF THE CITY OF MOUNTLAKE TERRACE ENGINEERING STANDARDS.
- 2. AN APPROVED COPY OF THESE PLANS MUST BE ON SITE WHENEVER CONSTRUCTION IS IN PROGRESS.

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- 3. IT SHALL BE THE SOLE RESPONSIBILITY OF THE CONTRACTOR TO OBTAIN STREET USE AND ANY OTHER RELATED PERMITS PRIOR TO ANY CONSTRUCTION ACTIVITY IN CITY RIGHT—OF—WAY.
- 4. PRIOR TO ANY CONSTRUCTION ACTIVITY, THE CITY OF MOUNTLAKE TERRACE ENGINEERING DEPARTMENT (425-776-1161) MUST BE CONTACTED FOR A PRECONSTRUCTION MEETING.
- 5. ALL LOCATIONS OF EXISTING UTILITIES SHOWN HEREON HAVE BEEN ESTABLISHED BY FIELD SURVEY OR OBTAINED FROM AVAILABLE RECORDS AND SHOULD THEREFORE BE CONSIDERED APPROXIMATE ONLY AND NOT NECESSARILY COMPLETE. IT IS THE SOLE RESPONSIBILITY OF THE CONTRACTOR TO INDEPENDENTLY VERIFY THE ACCURACY OF ALL UTILITY LOCATIONS SHOWN, AND TO FURTHER DISCOVER AND AVOID ANY OTHER UTILITIES NOT SHOWN HEREON WHICH MAY BE AFFECTED BY THE IMPLEMENTATION OF THIS PLAN. THE CONTRACTOR SHALL CONTACT THE UTILITIES UNDERGROUND LOCATION SERVICE (1–800–424–5555) PRIOR TO CONSTRUCTION. THE OWNER OR HIS REPRESENTATIVE SHALL BE IMMEDIATELY CONTACTED IF A UTILITY CONFLICT EXISTS.
- 6. CATCH BASINS, INLETS, YARD DRAINS, AND GRATES:
- A.ALL CATCH BASINS, INLETS, OR YARD DRAINS SHALL BE ONE OF THE FOLLOWING;
- YARD DRAIN CITY OF MOUNTLAKE TERRACE STANDARD PLAN NO. 407 OR EQUAL.
   CONCRETE INLET WSDOT B-25.60 OR EQUAL.
- 3. CATCH BASIN TYPE I WSDOT B-5.20 OR EQUAL
- 4. CATCH BASIN TYPE IL -WSDOT B-5.40 OR EQUAL
- 5. CATCH BASIN TYPE II WSDOT B-10.20 OR EQUAL
- 6. OTHER CATCH BASIN TYPES SHALL BE APPROVED FOR INSTALLATION BY THE CITY ENGINEER
- 7. ALL TYPE II CATCH BASINS SHALL HAVE LADDERS OR SAFETY STEPS PER CITY OF MOUNTLAKE TERRACE STANDARD PLAN NO. 306 OR EQUAL.
- B. LOCKING GRATES ARE REQUIRED ON ALL CITY RIGHT-OF-WAY AND CITY EASEMENT INSTALLATIONS. ALL GRATES SHALL BE ONE OF THE FOLLOWING:
- 1. CATCH BASINS TO BE CONSTRUCTED WITH A THROUGH-CURB INLET GRATE. SEE WSDOT STANDARD PLAN B-25.20
- 2. ALL OTHER GRATES SHALL BE DUCTILE IRON, AND OF THE LOCKING TYPE. WSDOT B-30.30 AND B-30.50 FOR GRADES
- EQUAL OR MORE THAN 4 PERCENT.

  3. ALL CATCH BASIN FRAME AND GRATES IN THE CURB LINE SHALL BE FLUSH WITH THE PAVEMENT/CURB LEVEL. SOLID
- FRAME AND LIDS IN THE TRAVELED ROADWAY SHALL BE FLUSH.
- 4. ALL OIL/WATER SEPARATOR AND DETENTION CONTROL CATCH BASIN GRATES SHALL BE OF THE LOCKING TYPE.
- 7. STORM SEWER PI
  - A. ALL STORM SEWER CONVEYANCE PIPE SHALL BE ONE OF THE FOLLOWING:
  - 1. CONCRETE, PER A.S.T.M. C-14, CLASS II, NON-REINFORCED BELL AND SPIGOT (WITH BELL FLUSH WITH C.B. WALL IF USED),
  - WITH RUBBER GASKETS.
  - 2. PVC CONFORMING TO A.S.T.M. D-3034 SDR 35.
  - 3. DUCTILE IRON CLASS 50 CONFORMING TO AWWA C 151.
  - 4. PIPE MAY BE ANY OF THE ABOVE PROVIDED:
  - a) PIPE JOINTS MUST BE OF THE SAME MATERIALS.
  - b)WHERE A PIPE MATERIAL IS SPECIFICALLY SHOWN ON THE PLAN, THAT MATERIAL MUST BE USED. ANY CHANGES TO THE PIPE MATERIAL SHOWN ON THE PLAN MUST BE PREAPPROVED.

    5. MINIMUM PIPE COVER IS DEPENDENT ON PIPE TYPE.
- 8. ALL PIPE BEDDING SHALL CONFORM TO STANDARDS SPECIFICATIONS SECTION 7-08.3(1)C, STANDARD SPECIFICATIONS FOR
- DUCTILE IRON, PVC PIPE, OR CONCRETE PIPE. ALL TRENCH BACKFILL SHALL BE COMPACTED MINIMUM 95% DRY OPTIMUM DENSITY PER ASTM D1557, OR LATEST REVISION, (MODIFIED PROCTOR).

  9. ALL PIPE SHALL BE LAID ON A PROPERLY PREPARED FOUNDATION ACCORDING TO STANDARD SPECIFICATIONS SECTION TO STANDARD SPECIFICATIONS SECTION AND ACCORDING TO STANDARD SPECIFICATIONS AND ACCORDING TO STANDARD SPECIFICATIONS AND ACCORDING TO STANDARD SPECIFICATION MATERIAL PROPERTY AND ACCORDING TO STANDARD SPECIFICATION ACCORDING TO STANDARD SP
- 7-08.3(2)B. THIS SHALL INCLUDE NECESSARY LEVELING OF THE TRENCH BOTTOM OR THE TOP OF THE FOUNDATION MATERIAL AS WELL AS PLACEMENT AND COMPACTION OF REQUIRED BEDDING MATERIAL TO UNIFORM GRADE SO THAT THE ENTIRE LENGTH OF THE PIPE WILL BE SUPPORTED ON A UNIFORMLY DENSE UNYIELDING BASE. IF THE NATIVE MATERIAL IN THE BOTTOM OF THE TRENCH MEETS THE REQUIREMENTS FOR "GRAVEL BACKFILL FOR PIPE ZONE BEDDING," STANDARD SPECIFICATIONS SECTION 9-03.12(3), THE FIRST LIFT OF PIPE BEDDING MAY BE OMITTED, PROVIDED THE MATERIAL IN THE BOTTOM OF THE TRENCH IS LOOSENED, REGRADED, AND COMPACTED TO FORM A DENSE UNYIELDING BASE.
- 10. ALL ROOF AND FOOTING DRAINS SHALL BE LOCATED IN THE FIELD AND ADJUSTED AS NECESSARY TO AVOID IMPACTING EXISTING TREES TO BE SAVED AS DENOTED ON THE GRADING PLAN. DRAIN LINES SHOULD BE LOCATED OUTSIDE THE DRIPLINE OF TREES TO BE SAVED WHENEVER POSSIBLE.
- 11. THE STORM DRAINAGE SYSTEM SHALL BE CONSTRUCTED ACCORDING TO THE APPROVED PLANS WHICH ARE ON FILE IN THE ENGINEERING DEPARTMENT. ANY DEVIATION FROM THE APPROVED PLANS WILL REQUIRE WRITTEN APPROVAL FROM THE PROPER AGENCY.
- 12. BUILDINGS SHALL NOT BE PERMITTED WITHIN 10 FEET OF THE SPRING LINE OF ANY STORM DRAIN PIPE, OR WITHIN 15 FEET OF THE TOP OF A CHANNEL BANK. STORM SEWERS 6" DIAMETER OR LESS MAY BE LOCATED WITHIN 30" OF A STRUCTURE PROVIDED THAT THE SOIL SUPPORT PRISM IS NOT DISTURBED FOR THE ADJACENT FOUNDATION.
- 13. PRIOR TO OCCUPANCY, THE PERMANENT STORM DRAINAGE SYSTEM MUST BE CLEANED OUT BY PUMPING. (DO NOT PUMP OR DISPOSE OF THIS WASTE INTO ANY STREAM, STORM SEWER, OR SANITARY SEWER SYSTEM.)
- 14. RIP RAP ROCK FOR EROSION PROTECTION SHALL BE OF SOUND QUARRY ROCK PLACED TO A MINIMUM DEPTH OF ONE (1) foot. ROCK AGGREGATE TO BE AS FOLLOWS:

ROCK SIZE	PERCENTAG
8 <b>"</b>	40% TO 70
2" TO 4"	20% TO 40
1/2" TO 2"	10% TO 40

- 15. TESTING OF ALL STORM SEWER PIPE WILL BE AT THE OPTION OF THE CITY OF MOUNTLAKE TERRACE. ALL PIPE WILL BE INSPECTED BY TV VIEWING.
- 16. WHEN PLAIN ALUMINUM PIPE ARCH IS USED WHERE IT WILL BE IN CONTACT WITH CONCRETE OR CONCRETE PIPE, ALL ALUMINUM SURFACES IN CONTACT WITH THE CONCRETE OR CONCRETE PIPE SHALL BE PAINTED WITH TWO COATS OF PAINT. THE ALUMINUM PIPE TO BE PAINTED SHALL BE CLEANED WITH SOLVENT TO REMOVE CONTAMINANTS. AFTER CLEANING, THE PIPE SHALL BE PAINTED WITH TWO COATS OF PAINT CONFORMING TO FEDERAL SPECIFICATION TT-P-645 (PRIMER, PAINT, ZINC CHROMATE, ALKYD VEHICLE).
- 17. AN AS BUILT STORM SEWER DRAWING SHALL BE SUBMITTED FOR ALL DEVELOPMENTS, SHORT PLATS, AND SUBDIVISIONS.
- 18. SAND COLLARS OR OTHER CITY APPROVED COUPLINGS ARE REQUIRED ON ALL PVC PIPE CONNECTIONS TO CONCRETE CATCH BASINS OR MANHOLES.
- 19. ALL STORM SEWERS SHALL BE DESIGNED AND CONSTRUCTED TO GIVE MEAN VELOCITIES, WHEN FLOWING FULL, OF NOT LESS THAN 3 FEET PER SECOND.
- 20. FOR CITY MAINTAINED STORM SYSTEMS, TRASH RACKS SHALL BE INSTALLED ON THE UPSTREAM END OF PIPES OR CULVERTS.

#### TESC General Notes

 PRIOR TO ANY CONSTRUCTION, RECONSTRUCTION, OR RENOVATION ACTIVITY, THE CITY OF MOUNTLAKE TERRACE ENGINEERING DEPARTMENT MUST BE CONTACTED FOR A PRECONSTRUCTION MEETING (425-776-1161).

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- 2. AN APPROVED COPY OF THESE PLANS MUST BE ON SITE AT ALL TIMES.
- 3. ALL LIMITS OF CLEARING AND AREAS OF VEGETATION PRESERVATION AS PRESCRIBED ON THE PLANS SHALL BE CLEARLY FLAGGED IN THE FIELD AND MAINTAINED DURING CONSTRUCTION.
- 4. WHERE POSSIBLE, MAINTAIN NATURAL VEGETATION FOR SILT CONTROL AND TO MINIMIZE EROSION CONTROL MEASURES, AND DIRECT SURFACE RUNOFF AWAY FROM THE EXPOSED AREAS, STEEP SLOPES, OR EROSION HAZARD AREA.
- 5. ALL REQUIRED SEDIMENTATION/EROSION CONTROL FACILITIES MUST BE CONSTRUCTED AND IN OPERATION PRIOR TO ANY LAND CLEARING AND/OR OTHER CONSTRUCTION TO INSURE THAT SEDIMENT—LADEN WATER DOES NOT ENTER THE NATURAL DRAINAGE SYSTEM OR OFF—SITE STORM DRAINS. (SEE CONSTRUCTION SEQUENCE.) ALL EROSION AND SEDIMENT FACILITIES SHALL BE MAINTAINED IN A SATISFACTORY CONDITION UNTIL SUCH TIME THAT CLEARING AND/OR CONSTRUCTION IS COMPLETED AND THE POTENTIAL FOR ON—SITE EROSION HAS PASSED. SYSTEM IMPLEMENTATION, MAINTENANCE, AND REPLACEMENT SHALL BE THE RESPONSIBILITY OF THE PERMITTEE, ALONG WITH ANY REQUIRED ADDITIONS.
- 6. THE EROSION AND SEDIMENTATION CONTROL SYSTEMS DEPICTED ARE INTENDED TO BE MINIMUM REQUIREMENTS TO MEET ANTICIPATED SITE CONDITIONS. AS CONSTRUCTION PROGRESSES AND UNEXPECTED OR SEASONAL CONDITIONS DICTATE, THE PERMITTEE SHOULD ANTICIPATE THAT MORE EROSION AND SEDIMENTATION CONTROL FACILITIES MAY BE NECESSARY TO INSURE COMPLETE EROSION AND SEDIMENT CONTROL ON THE SITE. DURING THE COURSE OF CONSTRUCTION, IT SHALL BE THE OBLIGATION AN RESPONSIBILITY OF THE PERMITTEE TO ADDRESS ANY NEW CONDITIONS THAT MAY BE CREATED BY HIS ACTIVITIES AND TO PROVIDE ADDITIONAL FACILITIES, OVER AND ABOVE MINIMUM REQUIREMENTS SHOWN, AS MAY BE NEEDED TO PROTECT ADJACENT PROPERTIES AND WATER QUALITY OF THE RECEIVING DRAINAGE SYSTEM. ADDITIONAL MEASURES MAY ALSO BE REQUIRED BY THE CITY OF MOUNTLAKE TERRACE INSPECTOR.
- 7. APPROVAL OF THE PLAN IS FOR EROSION/SEDIMENTATION CONTROL ONLY. IT DOES NOT CONSTITUTE AN APPROVAL OF STORM DRAINAGE DESIGN, SIZE OR LOCATION OF PIPES, RESTRICTORS, CHANNELS, OR RETENTION FACILITIES.
- 8. IN ANY WORK WHICH HAS BEEN STRIPPED OF VEGETATION AND WHERE NO FURTHER WORK IS ANTICIPATED FOR A PERIOD OF 30 DAYS OR MORE, ALL DISTURBED AREAS MUST BE IMMEDIATELY STABILIZED WITH BY MULCHING, HYDROSEEDING, OR OTHER APPROVED EROSION CONTROL MEASURE APPLICABLE TO THE TIME OF YEAR IN QUESTION. GRASS SEEDING ALONE WILL BE ACCEPTABLE ONLY DURING THE MONTHS OF APRIL THROUGH SEPTEMBER INCLUSIVE. SEEDING MAY PROCEED WHENEVER IT IS IN THE INTEREST OF THE PERMITTEE, BUT MUST BE AUGMENTED WITH MULCHING, NETTING, OR OTHER MEASURES APPROVED BY THE CITY OF MOUNTLAKE TERRACE, OUTSIDE OF THE SPECIFIED TIME PERIOD.
- 9. GRASS SEEDING SHALL BE DONE USING AN APPROVED TYPE HYDRO—SEEDER, OR AS OTHERWISE APPROVED BY THE CITY OF MOUNTLAKE TERRACE. SEED MIX SHALL CONSIST OF RAPID, PERSISTENT, AND LEGUME GRASSES (MIN. 80LB. PER ACRE) AS NOTED BELOW UNLESS OTHERWISE APPROVED BY THE CITY ENGINEER:
  - 70% PERENNIAL RYEGRASS(3 VARIETIES)
  - 30% RED AND/OR CHEWINGS FESCUES(2 VARIETIES)
- 10. STRAW MULCH SHALL CONSIST OF A MINIMUM THICKNESS OF FOUR (4) INCHES SPREAD EVENLY OVER THE SURFACE TO BE PROTECTED. MULCH MUST BE PROPERLY ANCHORED TO THE GROUND. NETTING MAY BE REQUIRED TO HOLD MULCH IN PLACE ON STEEP SLOPES.
- 11. A MINIMUM THREE (3) FOOT HIGH CHAIN LINK FENCE SHALL BE CONSTRUCTED AROUND ANY POND USED FOR TEMPORARY EROSION/SEDIMENTATION CONTROL SEDIMENTATION AND/OR DETENTION WHEN IT CAN BE EXPECTED THAT THE WATER DEPTH WILL EXCEED ONE (1) FOOT.
- 12. THE CONTRACTOR SHALL ASSURE THAT NO CONCRETE OR CONCRETE BY—PRODUCTS, CHEMICALS, PAINTS, GLUES, OR ANY OTHER POLLUTANTS ENTER THE STORM DRAINAGE SYSTEM OR NATURAL STREAM COURSES.
- 13. REMOVE ALL TEMPORARY EROSION CONTROL MEASURES WHEN THE EROSION HAZARD IS COMPLETELY OVER. REMOVE ALL DEPOSITED SEDIMENT AND DEBRIS AND REHABILITATE THE DISTURBED AREAS BY PLANTING VEGETATIVE COVER AS REQUIRED BY THE CITY OF MOUNTLAKE TERRACE.
- 14. THE APPLICANT SHALL PROVIDE FOR A CERTIFIED PROFESSIONAL IN EROSION AND SEDIMENT CONTROL TO BE ONSITE OR ON—CALL AT ALL TIMES. A SPILL CONTROL KIT SHALL BE KEPT ON—SITE FOR ALL CONSTRUCTION EQUIPMENT.

RECORD DRAWING NOTES

PERIOD.

THIS DRAWING SET REFLECTS ON-SITE CHANGES FROM

CONTRACTOR PROVIDED AS-BUILT DRAWINGS, AND DESIGN CHANGE DRAWINGS DEVELOPED DURING THE CONSTRUCTION

THE LOCATION AND DIMENSIONS OF ELEMENTS PROVIDED

OF DRAWINGS IS HIGHLIGHTED BY CLOUDS

HEREIN THAT WERE CHANGED FROM THE CONSTRUCTION SET

# Evergreen Playfield

22231 56th Ave W.
Mountlake Terrace, WA 98043

Robert W. Droll



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> Landscape Architecture Site Planning Environmental Design

Urban Design Land Planning Project Management



Consulting Engineers

612 Woodland Square Loop SE, Suite Lacey, Washington 98503

Project Record Drawings

(360) 292-7230 Fax (360) 292-7231

URAWING	
DESIGNED BY_	BD, DC, R1
DEAWN BY	Rī, Pv
CHECKED BY_	BC

PROJECT NO.

5 RE VISION
DATE CHANGE

DATE: January 10, 2022

**General Note** 

G1.1

Sheet 2 of 19

RECORD DRAWING NOTES

THIS DRAWING SET REFLECTS ON-SITE CHANGES FROM CONTRACTOR PROVIDED AS-BUILT DRAWINGS. AND DESIGN CHANGE DRAWINGS DEVELOPED DURING THE CONSTRUCTION

THE LOCATION AND DIMENSIONS OF ELEMENTS PROVIDED HEREIN THAT WERE CHANGED FROM THE CONSTRUCTION SET OF DRAWINGS IS HIGHLIGHTED BY CLOUDS

HORIZONTAL DATUM: THE WASHINGTON STATE PLANE COORDINATE SYSTEM, NORTH ZONE NAD83(2011), AS EXTENDED TO THE PROJECT SITE UTILIZING REAL-TIME (RTK) GPS

PRIMARY SURVEY CONTROL POINTS USED:

G

<u>GP31005-204:</u> METAL ROD AND WSDOT ALUMINUM DISC IN THE NORTHWEST QUADRANT SR-005 AND 220TH ST SW. 2. GP31005-40: WSDOT BRASS DISC IN NORTHERLY CONCRETE WALKWAY OF 236TH ST SW

VERTICAL DATUM: NAVD88, US FEET, AS PRESCRIBED BY THE CITY OF MOUNTLAKE TERRACE.

Н

CITY OF MOUNTLAKE TERRACE BENCHMARK:

CHISELED SQUARE IN NW. CORNER OF CONCRETE PAD FOR BUS STOP SHELTER ON THE EAST SIDE OF 56TH AVE. W, OPPOSITE HOUSE# 22106 ELEVATION = 516.08'

2" BRONZE CAP STAMPED "CITY OF MOUNTLAKE TERRACE BM#009, 0.4' SOUTH AND 0.4' WEST OF NORTHEAST CORNER OF CONCRETE PAD FOR BUS STOP SHELTER ON EAST SIDE OF 56TH AVE. W. 100' NORTH OF INTERSECTION WITH 224TH ST. S.W. ELEVATION = 515.91

SITE BENCHMARK:

TBM#1 DHA 2992-50

REBAR AND DHA CONTROL CAP 160.4' EAST AND 95.9' NORTH OF BM#164 ELEVATION = 516.24

CONTOUR INTERVAL: (1) ONE FOOT CONTOURS

<u>LINETYPES</u>: RIGHT OF WAY CENTERLINE RIGHT OF WAY BOUNDARY LINE PLATTED LOT LINE UNDERGROUND STORM LINE UNDERGROUND SEWER LINE UNDERGROUND TELEPHONE LINE WATER LINE UNDERGROUND POWER LINE ASPHALT WALK FENCE LINE YUYUYUYUYUYUYU GRAVEL ROAD

	<u>LEGEND</u> :	ADDD	EVIATIONS:
ᅶ	LICUT DOLE	ADDKI	<u>L VIA HONS.</u>
<b>*</b> -	LIGHT POLE	PRD	PER RECORD DRAWING
	CATCH BASIN	CONC	CONCRETE
	CONIFER TREE	PRD	PER RECORD DRAWING
$\bigcirc$	DECIDUOUS TREE	SH	SPRINKLER HEAD
ъ.	SIGN	ΙΕ	INVERT ELEVATION
	DHA SURVEY CONTROL	ВОТ	BOTTOM STRUCTURE
•	MONUMENT IN CASE	PVC	POLY VINYL CHLORIDE PIF
•	BENCHMARK	СМР	CORRUGATED METAL PIPE
$\bowtie$	VALVE	CIVIP	
cQ	SANITARY CLEAN-OUT	CB	CATCH BASIN
⊞	WATER METER	F	FIR TREE
T	TELEPHONE VAULT	М	MAPLE TREE
-(	CULVERT	P	PINE TREE
$\sim$	ROCKERY	MAD	MADRONA TREE
		С	CEDAR TREE
		FT	FRUIT TREE
		SEQ	SEQUOIA TREE
		ORN	ORNAMENTAL TREE
		DEC	DECIDUOUS TREE

1. ALL MONUMENTS VISITED DURING FEBRUARY 2020 UNLESS OTHERWISE NOTED.

2. EQUIPMENT: THE PRIMARY MEASUREMENT EQUIPMENT UTILIZED IN THE PERFORMANCE OF THIS SURVEY WAS A LEICA MS-60 ELECTRONIC TOTAL STATION, SN# 883508.

HOLLY TREE

3. THIS SURVEY COMPLIES WITH ALL STANDARDS AND GUIDELINES OF THE SURVEY RECORDING ACT AS PER CHAPTER 58.09 RCW AND CHAPTER 332-130 WAC.

4. THIS SURVEY WAS PERFORMED WITHOUT THE BENEFIT OF A CURRENT TITLE REPORT. THERE MAY BE EASEMENTS OR OTHER DOCUMENTS OF RECORD THAT EFFECT THIS PARCEL THAT WOULD BE DISCLOSED BY THE PROCUREMENT OF A CURRENT TITLE

5. THIS SURVEY REPRESENTS THE EXISTING PLANIMETRIC FEATURES AS THEY EXISTED ON SITE IN FEBRUARY 2020.

6. PROPERTY LINES SHOWN HEREON GENERATED FROM SNOHOMISH COUNTY COUNTY ASSESSORS RECORDS AND ARE CONSIDERED APPROXIMATE IN LOCATION.

#### SITE ADDRESS:

10' 20' 30' 40'

NOTES:

22231 56TH AVE W., MOUNTLAKE TERRACE, WA 98043..

SNOHOMISH COUNTY TAX PARCEL No. 52000010-0200.

TOPOGRAPHIC MAPPING:
THE MAP SHOWN HEREON IS THE RESULT OF A TOPOGRAPHIC SURVEY BY DUANE HARTMAN & ASSOCIATES, INC. (DHA) COMPLETED IN FEBRUARY 2020. DHA ASSUMES NO LIABILITY, BEYOND SAID DATE, FOR ANY FUTURE SURFACE FEATURE MODIFICATIONS OR CONSTRUCTION ACTIVITIES THAT MAY OCCUR WITHIN OR ADJOINING THE PERIMETER OF THIS SURVEY. CONTACT DHA (425/483-5355) FOR SITE UPDATES AND VERIFICATIONS.

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## Evergreen **Playfield**

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Robert W. Droll



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Project Record Drawings

	PROJEC	T NO	19068
<b>—</b>	DRAWIN	G	
		ED BY BY	
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5	<u>REVISIO</u>		
	DATE	CHANGE	
	DATE:	January 10	, 2022

**Existing Conditions -**Sheet 1

Sheet 3 of 19

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<u>LINETYPES</u> :	
	RIGHT OF WAY CENTERLINE
	RIGHT OF WAY
	BOUNDARY LINE
	PLATTED LOT LINE
——————————————————————————————————————	UNDERGROUND STORM LINE
	UNDERGROUND SEWER LINE
тт	UNDERGROUND TELEPHONE LINE
	WATER LINE
————— E ———	UNDERGROUND POWER LINE
	ASPHALT WALK
X	FENCE LINE
UMUMUMUMUMUMUM	GRAVEL ROAD

	SYMBOLS:	<u>ABBR</u>	EVIATIONS:
*	LIGHT POLE	PRD	PER RECORD DRAWING
	CATCH BASIN	CONC	CONCRETE
$\underset{\sim}{\times}$	CONIFER TREE	PRD	PER RECORD DRAWING
$\bigcirc$	DECIDUOUS TREE	SH	SPRINKLER HEAD
Т	SIGN	ΙΕ	INVERT ELEVATION
$\triangle$	DHA SURVEY CONTROL	вот	BOTTOM STRUCTURE
•	MONUMENT IN CASE	PVC	POLY VINYL CHLORIDE
•	BENCHMARK		CORRUGATED METAL F
$\bowtie$	VALVE	CMP	
cq	SANITARY CLEAN-OUT	CB -	CATCH BASIN
$\blacksquare$	WATER METER	F	FIR TREE
T	TELEPHONE VAULT	М	MAPLE TREE
-(	CULVERT	Р	PINE TREE
	ROCKERY	MAD	MADRONA TREE
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		FT	FRUIT TREE
		SEQ	SEQUOIA TREE
		ORN	ORNAMENTAL TREE
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NOTES:		Н	HOLLY TREE

PIPE

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Robert W. Droll Landscape Architect, PS



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> > Urban Design Land Planning Project Management




Project Record Drawings

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5	REVISIO DATE	N CHANGE
<b>4</b>	DATE:	January 10, 2022

PROJECT NO.

**Existing Conditions -**Sheet 2

Sheet 4 of 19

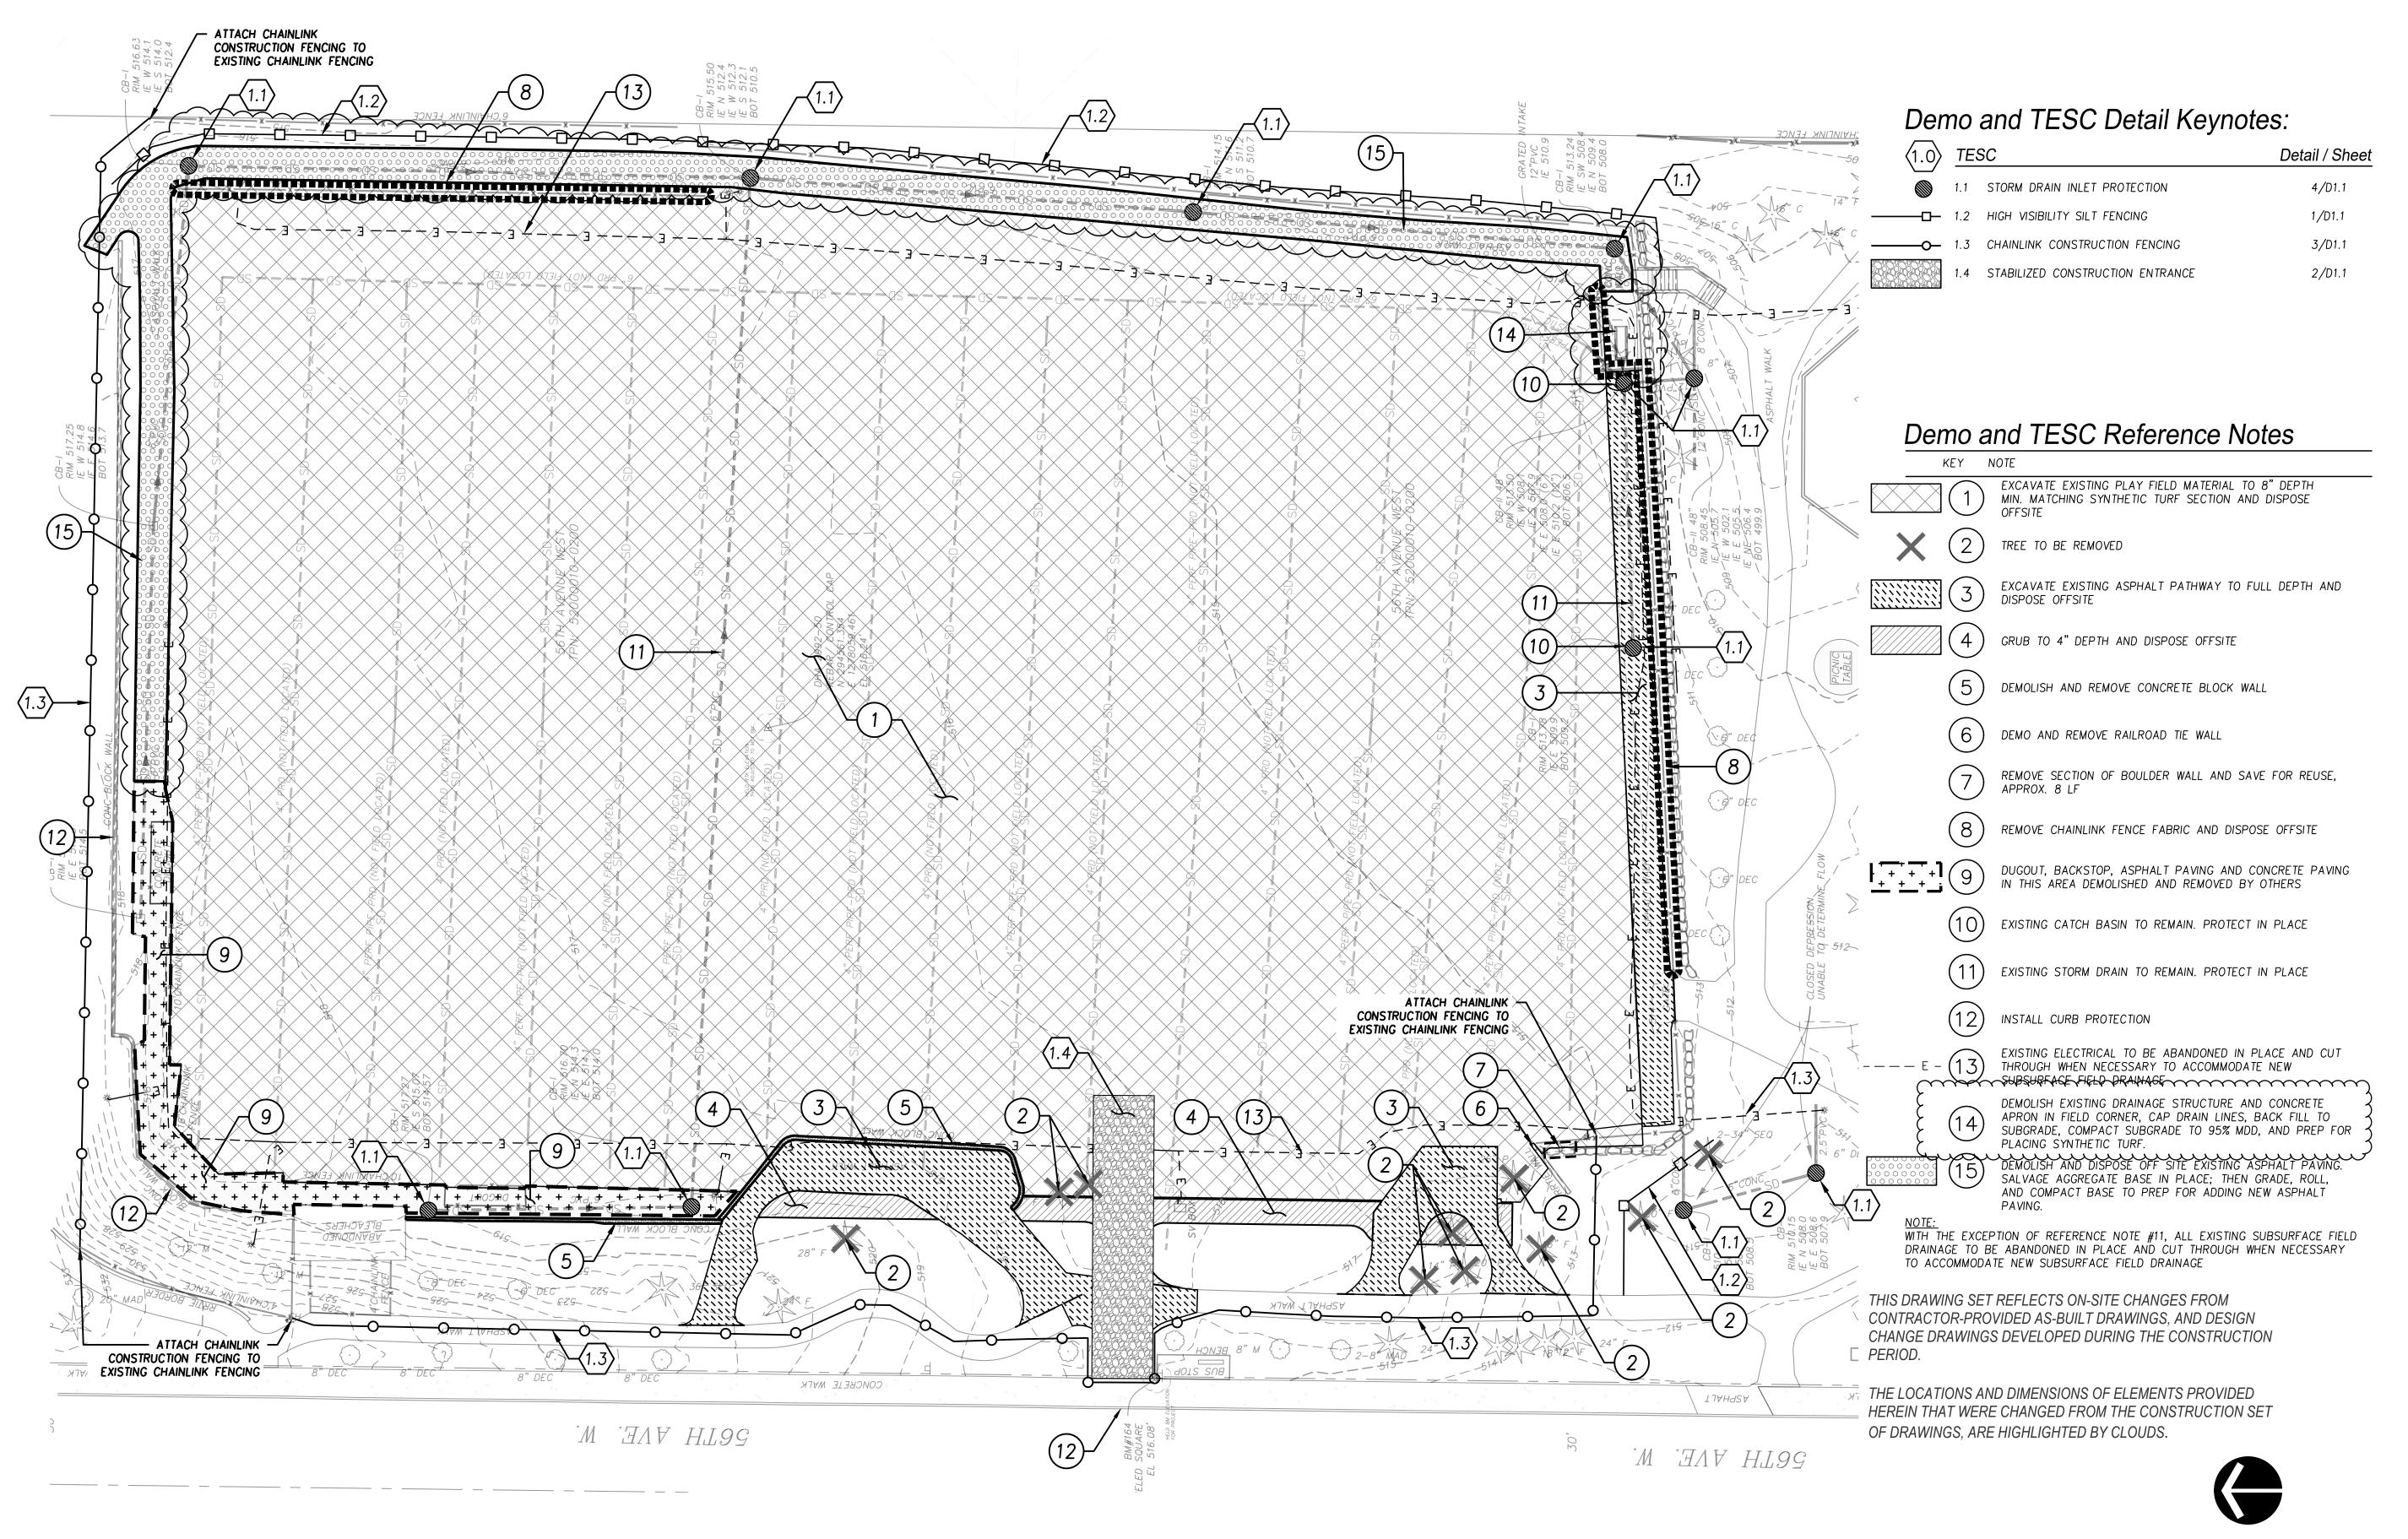

# **Evergreen Playfield**

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# Project Record Drawings

<b>4</b>	DRAWING	
	DESIGNED BY_	BD, DC, R1
	DRAWN BY	RT, PV
	CHECKED BY_	ВС

PROJECT NO. .

5	REVISIO DATE	N CHANGE
	DATE:	January 10, 2022


# Demo and TESC Plan

D1.0

Sheet <u>5</u> of <u>19</u>

## High Visibility Silt Fence

D1.1 SCALE: NTS

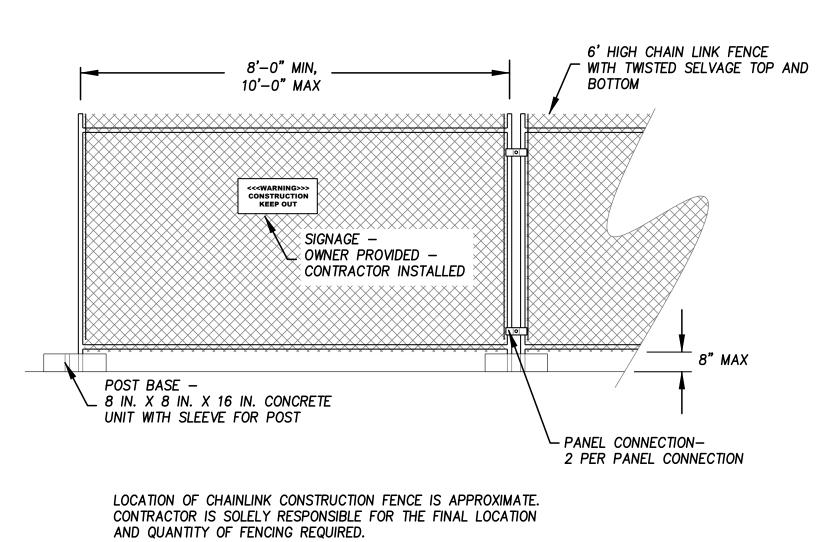

#### **Chainlink Construction Fencing** D1.1 SCALE: NTS

NOT TO SCALE IF APPROVED BY INSPECTOR, 100' MIN. MAY BE REDUCED TO 50' MIN. FOR SITES WITH LESS THAN 1 ACRE OF EXPOSED SOIL. Install driveway culvert if there is a roadside ditch present Driveway shall meet 12" minimum thickness the requirements of the permitting agency. Provide full width 2. It is recommended that the entrance be of ingress/egress crowned so that runoff drains off the pad. Figure II-4.1.1 THIS DRAWING SET REFLECTS ON-SITE CHANGES FROM Stabilized Construction Entrance CONTRACTOR-PROVIDED AS-BUILT DRAWINGS, AND DESIGN CHANGE DRAWINGS DEVELOPED DURING THE

G

CONSTRUCTION PERIOD.

BY CLOUDS.

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#### **Stabilized Construction Entrance** D1.1 SCALE: NTS

limitation of liability, and disclaimer.

1. Size the Below Inlet Grate Device (BIGD) for the storm water structure it 2. The BIGD shall have a built-in high-flow relief system (overflow bypass). 3. The retrieval system must allow removal of the BIGD without spilling the 4. Perform maintenance in accordance with Standard Specification 8-01.3(15). DRAINAGE GRATE DRAINAGE GRATE ~ RECTANGULAR GRATE SHOWN RETRIEVAL SYSTEM (TYP.) SEDIMENT AND DEBRIS -OVERFLOW BYPASS - BELOW INLET GRATE DEVICE FILTERED \_ WATER BELOW INLET GRATE DEVICE -OVERFLOW BYPASS (TYP.) SECTION VIEW ISOMETRIC VIEW NOT TO SCALE STORM DRAIN **INLET PROTECTION** STANDARD PLAN I-40.20-00 SHEET 1 OF 1 SHEET APPROVED FOR PUBLICATION Pasco Bakotich III 09-20-07

# **Storm Drain Inlet Protection**

D1.1 SCALE: NTS

Evergreen Playfield

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E-MAIL bob@rwdroll.com Landscape Architecture Site Planning Environmental Design

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Lacey, Washington 98503 (360) 292-7230 Fax (360) 292-7231

> **Project Record** Drawings


DRAWING BD, DC, RT DESIGNED BY\_ RT, PV DRAWN BY CHECKED BY

PROJECT NO.

REVISION DATE CHANGE January 10, 2022 DATE:

**Demo and TESC Details** 

Sheet <u>6</u> of <u>19</u>

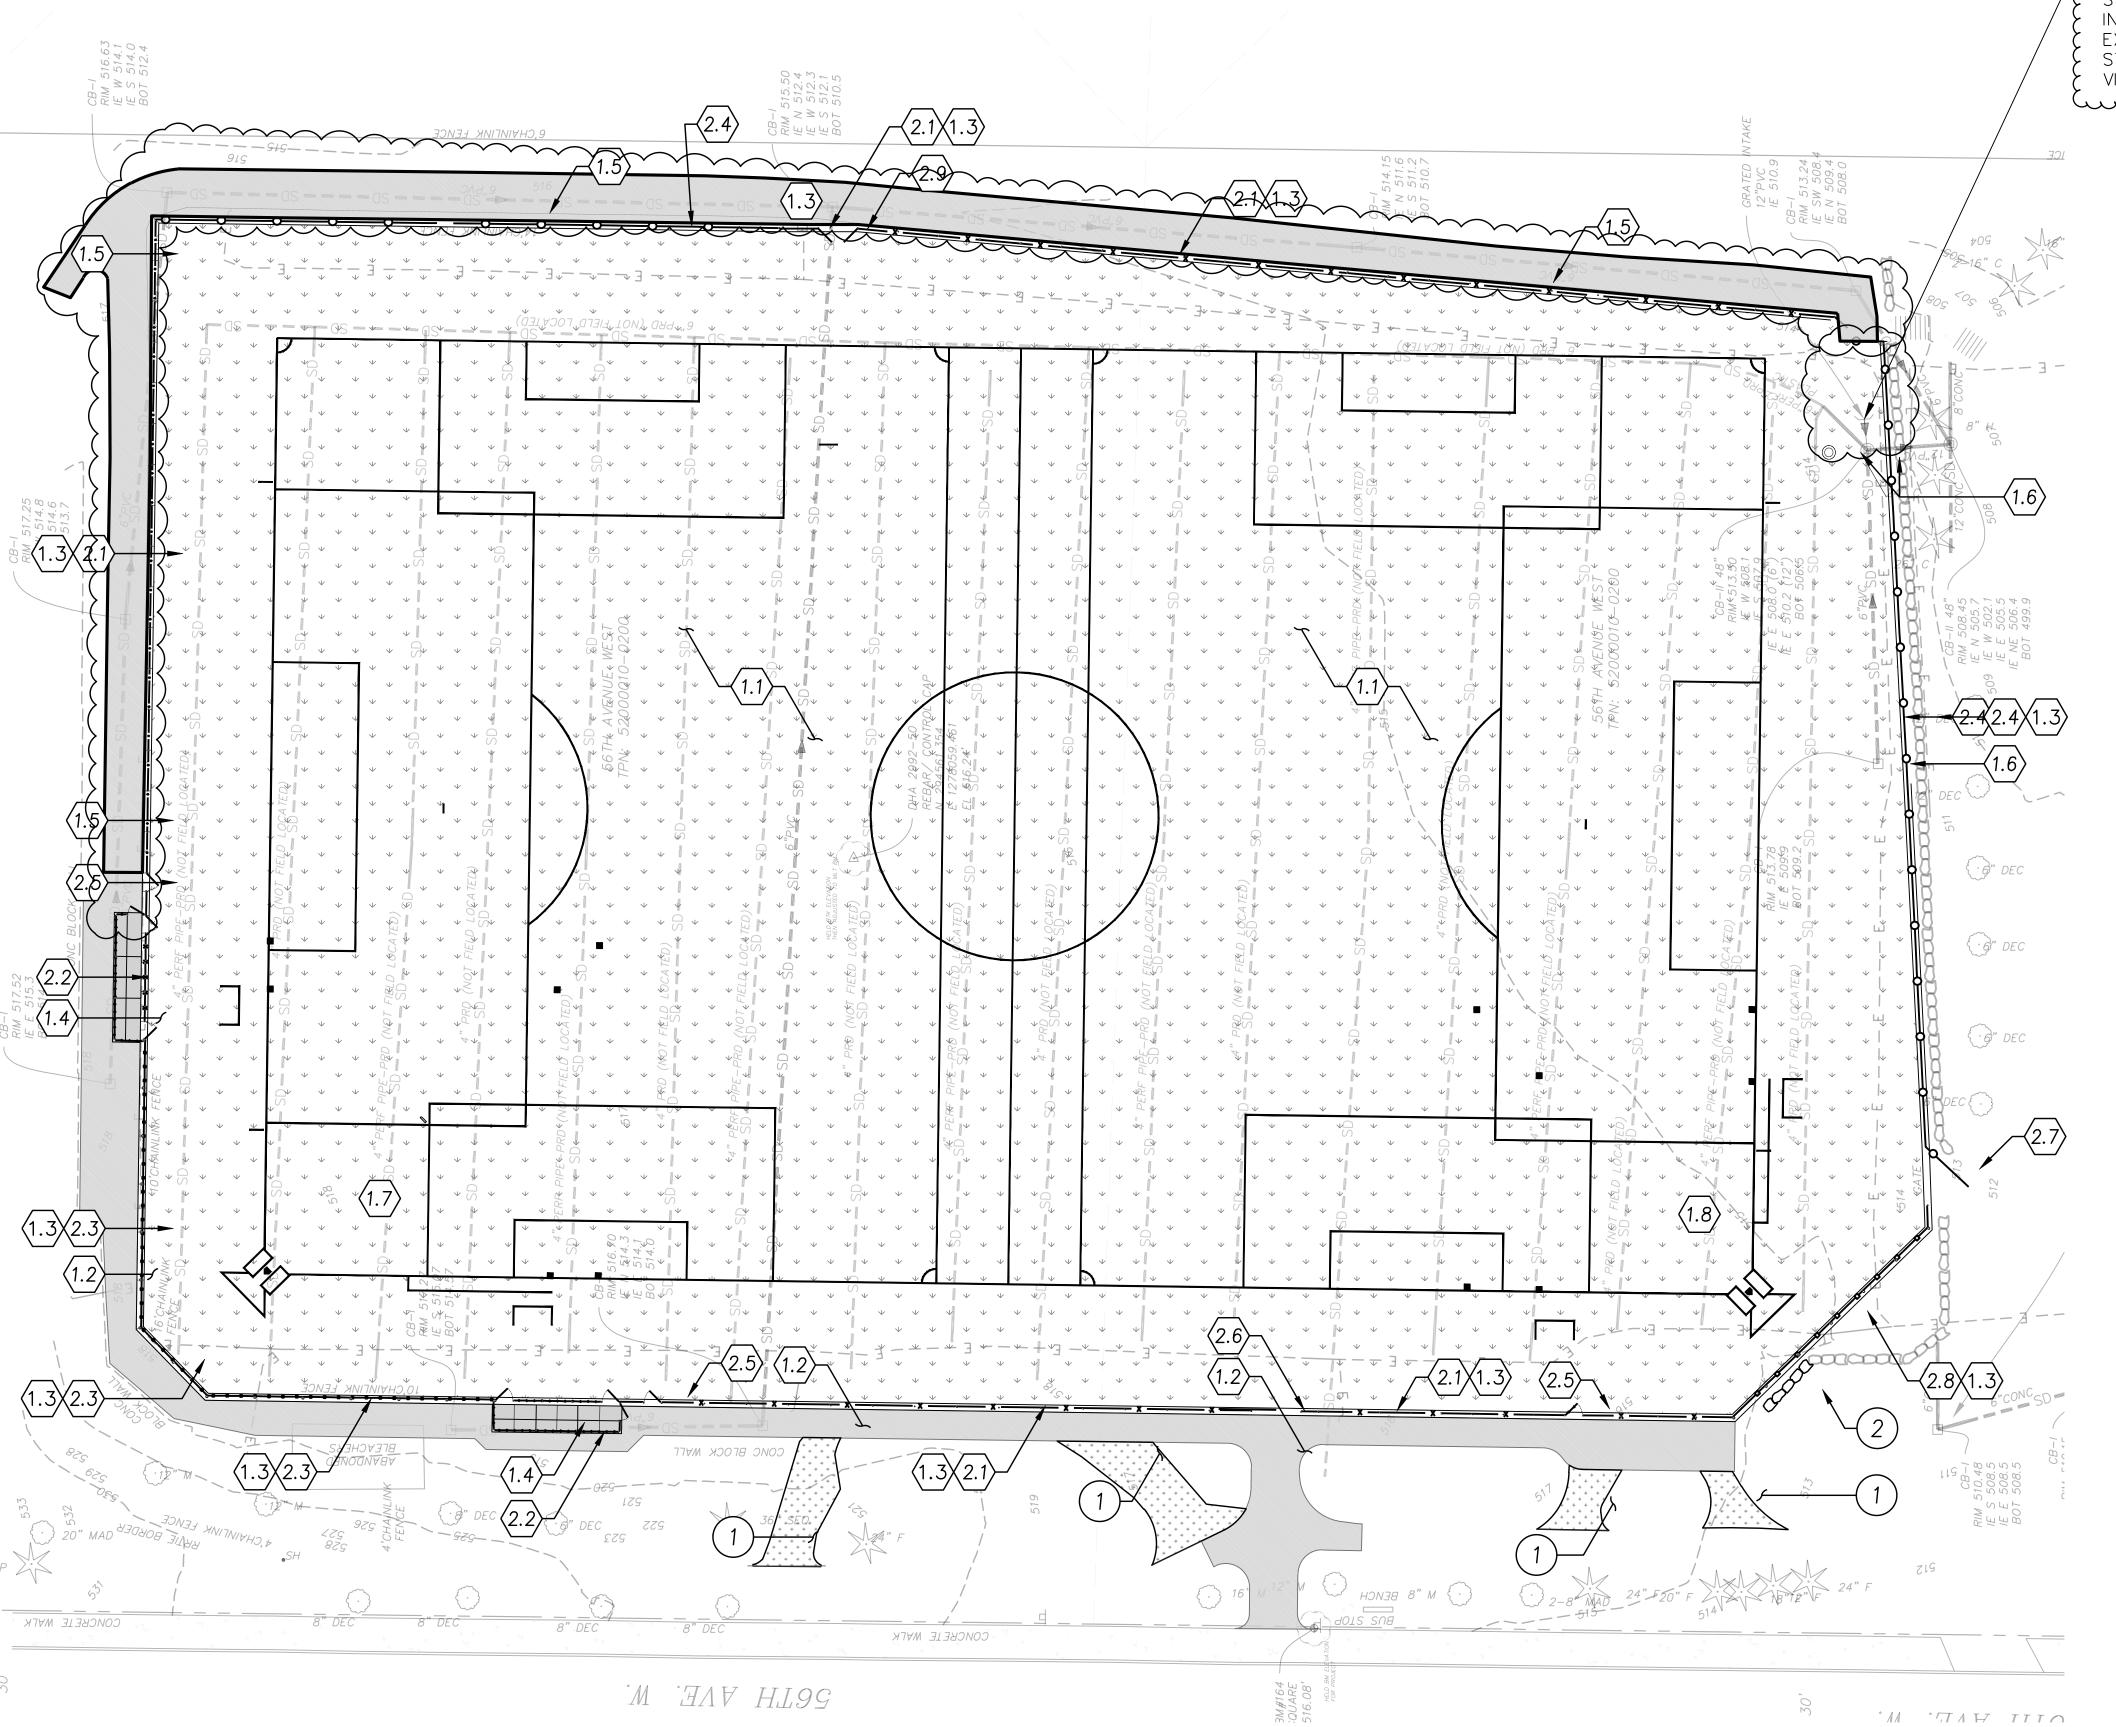

— SYNTHETIC TURF INSTALLED IN THIS AREA WHERE EXISTING DRAINAGE STRUCTURE WAS REMOVED VIA CHANGE ORDER

#### Site Plan Detail Keynotes:

$\langle 1.0 \rangle$	Sur	facing	Detail / She
\(\frac{1}{2}\)	1.1	SYNTHETIC TURF	1/C4.0
	1.2	ASPHALT PAVING	2/C4.0
	1.3	CEMENT CONCRETE NAILER CURB	5/C4.0
	1.4	CEMENT CONC. PAVING	3/C4.0
	1.5	NOT USED	
	1.6	SOLID DRYWELL/CATCH BASIN COVER W/ SYN. TUR	PF CAP 5/C3.1
	1.7	LITTLE LEAGUE FIELD LAYOUT	1/C6.0
	1.8	TEE BALL FIELD LAYOUT	2/C6.0

$\langle 2.0 \rangle$	Fencing		Detail / Sheet	
×	2.1	6' CHAINLINK FENCE	1/C4.1	
—x—x—	2.2	8' CHAINLINK DUGOUT (Covered Under Bldg Permit)	C5.2, C5.3	
	2.3	LITTLE LEAGUE CHAINLINK BACKSTOP (Covered Under Bldg Permit)	C5.0, C5.1	
<b></b>	2.4	REFURBISHED EXISTING 10' CHAINLINK FEN (Replacing Chainlink Fabric Only)	ICE 3/C4.1	
	2.5	3.5' WIDE 6' CHAINLINK GATE	2/C4.1	
	2.6	12' WIDE VEHICULAR SLIDING GATE	1/C4.2	
	2.7	REFURBISHED EXISTING CHAINLINK GATE (Replacing Chainlink Fabric Only)	3/C5.3	
<del></del> 0	2.8	TEE BALL BACKSTOP (Covered Under Bldg Permit)	4/C5.3	
	2.9	8' WIDE DOUBLE SWING GATE	4/C4.1	

#### Site Plan Reference Notes


KEY NOTE

1) LANDSCAPE RESTORATION AREA

BOULDER WALL EXTENSION, BY OTHERS, NIC

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## Evergreen Playfield

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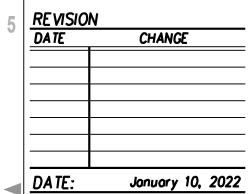
> Landscape Architectur Site Plannin Environmental Desig

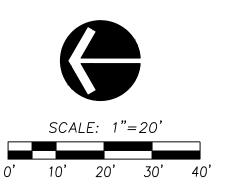Urban Design Land Planning Project Management



#### Project Record Drawings


	PROJECT NO190		
<b>4</b>	DRAWING		
,	DESIGNED BY_	BD, DC, RT	
	DRAWN BY	RT, PV	
	CHECKED BY_	BD	



Site Plan

C1.0

Sheet \_ 7 \_ of \_ 19

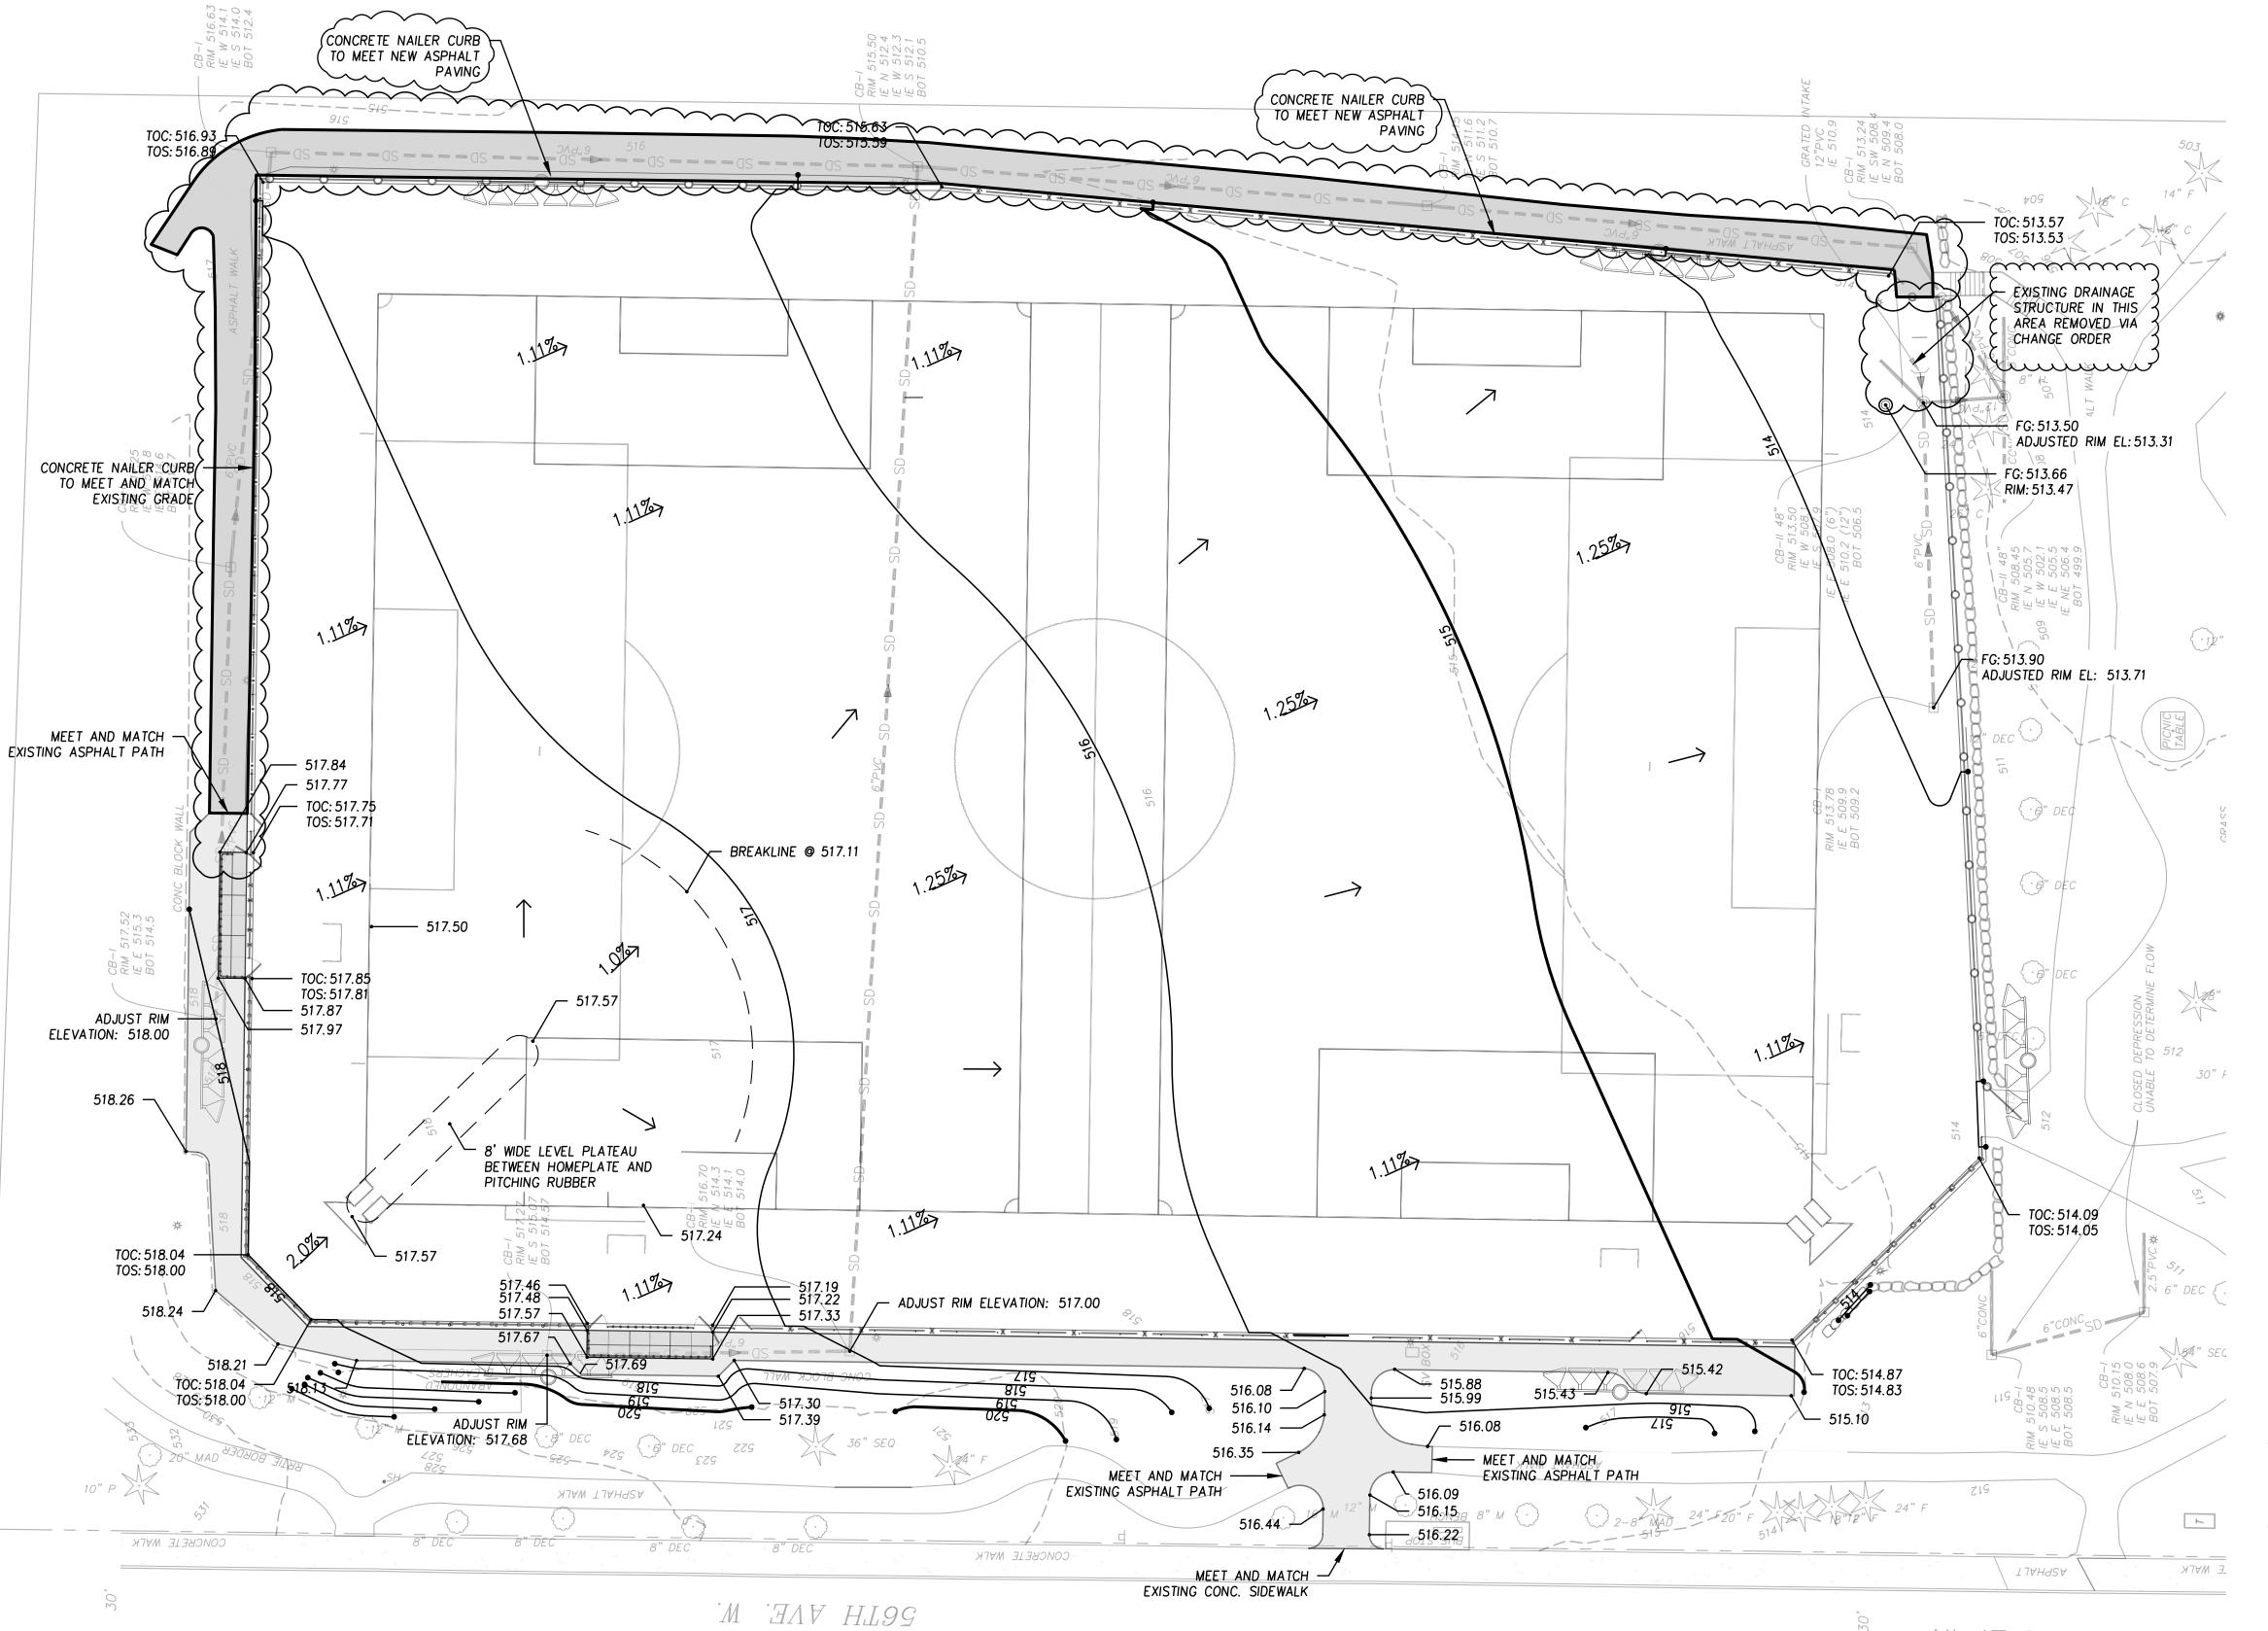

#### Grading Plan Legend

Key	Note
515	CONTOUR - MAJOR
514	CONTOUR - MINOR
TOC: 500	TOP OF CURB SPOT ELEVATION
TOS: 500	TOP OF SYNTHETIC TURF SPOT ELEVATION
1.0%	SLOPE PERCENT

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PROJECT NO. \_

**DRAWING** 

DATE:

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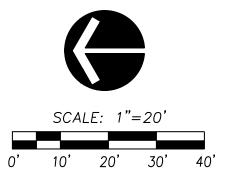
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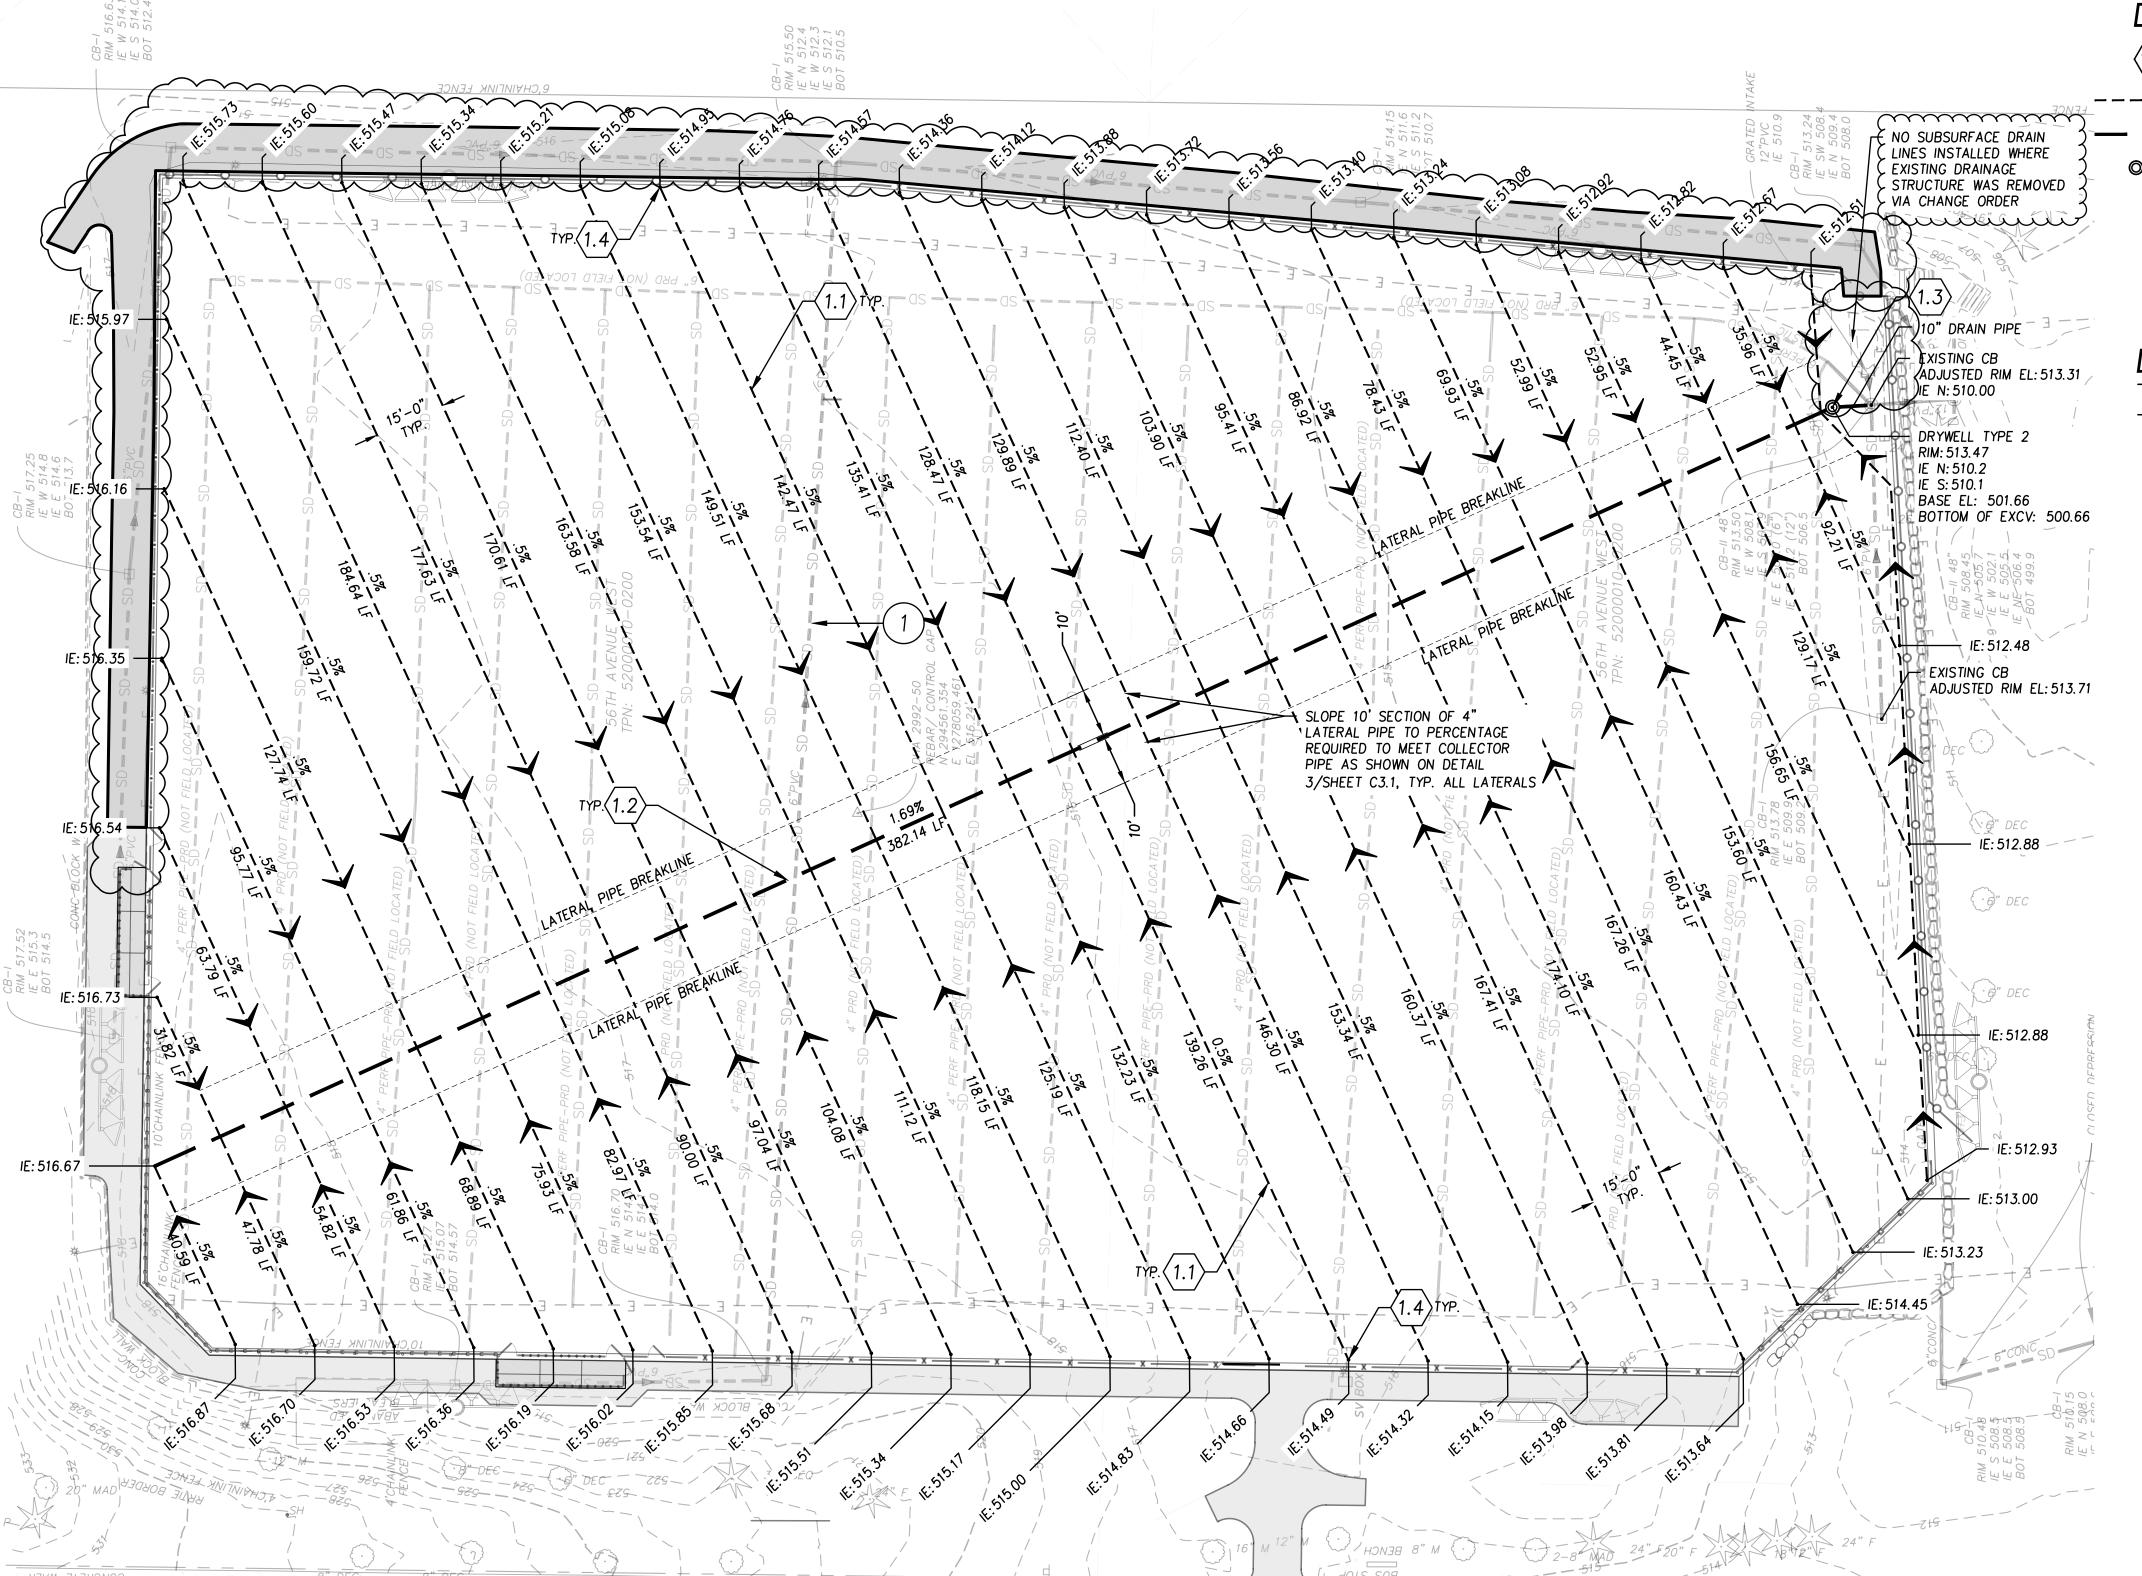


January 10, 2022

C2.0

Sheet <u>8</u> of <u>19</u>





CONCRETE WALK

D

#### Drainage Plan Detail Keynotes:

	$\langle 1.0 \rangle$	Drainage		Detail / Sl
		1.1	4" SUBDRAIN LATERAL PIPE	1/C3.1
	- —	1.2	8" COLLECTOR PIPE	3/C3.:
_	<b>©</b>	1.3	DRYWELL TYPE 2	4/C3.
		1.4	SUBDRAIN LATERAL PIPE TERMINUS	2/C3.


#### Drainage Plan Reference Notes

k	ŒΥ	NOTE

1 EXISTING STORM DRAIN TO REMAIN. PROTECT IN PLACE

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,						
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	DRAWN	BY_			RT,	PV
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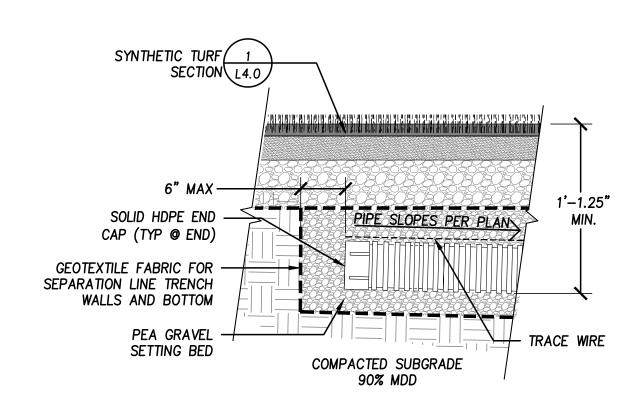
#### **Drainage Plan**

January 10, 2022

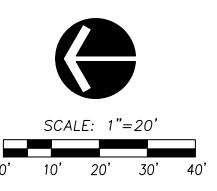DATE:

C3.0

Sheet 9 of 19



E

# SYNTHETIC TURE 4" SLOTTED HDPE LATERAL. SLOPE TRENCH TO COLLECTOR PEA GRAVEL DRAINAGE STONE 8" SLOTTED HDPE COLLECTOR 8" SLOTTED HDPE COLLECTOR ENTEROIS FABRIC FOR SEPARATION. LINE TRENCH AND EXTEND PAST TOP EDGES 18 INCHES. SECURE TO SUBGRADE WITH SOD STAPLES SET EVERY 36 IN. PEA GRAVEL BEDDING

#### 1 4" Subdrain Lateral Pipe C3.1 SCALE: 1½" = 1'-0"


Subdrain Lateral Pipe Terminus

SCALE: 1½" = 1'-0"

3 8" Collector Pipe C3.1 SCALE: 1½" = 1'-0"

SOLID DRYWELL COVER W/ 5
SYNTHETIC TURF CAP C3.1 - FINISH GRADE: 513.66 RIM: 513.47 CIRCULAR FRAME AND SOLID COVER SYNTHETIC ( 1 4" CONC. SLAB -INLET PIPE, — SEE NOTE 2 FLOW\_\_\_ IE: 510.20 - IE: 510.10 GRAVEL BACKFILL FOR DRYWELL SEEPAGE PORT ORIENTATION VARIES AMONG
 MANUFACTURERS LIMIT OF EXCAVATION 1H: 2V SLOPE (MAX.) 2. CONNECT INLET PIPE TO STRUCTURE USING PRECAST HOLE OF CORE DRILLED HOLE - SEEPAGE PORT-SEE NOTE 1 UNDERGROUND DRAINAGE ———
GEOTEXTILE, MODERATE SURVIVABILITY, CLASS A 0 2 0 2 0 a 0 a 0 a

4 Drywell - Type 2
C3.1 SCALE: NTS

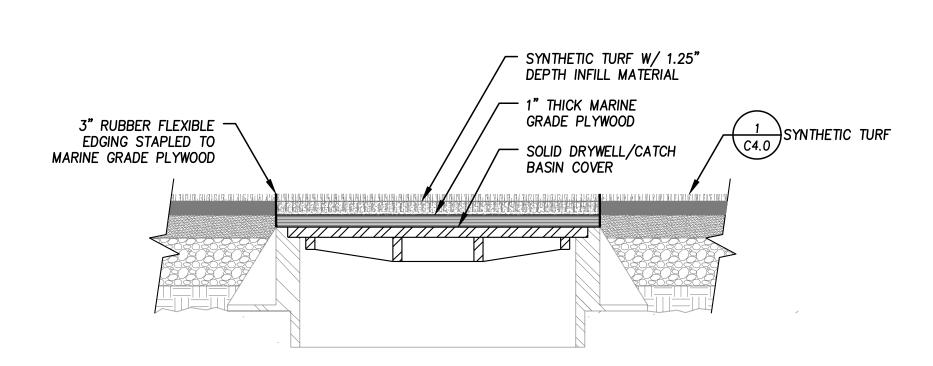

Solid Drywell/Catch Basin Cover w/ Synthetic Turf Cap (C3.1)

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# **Evergreen Playfield**

22231 56th Ave W. Mountlake Terrace, WA 98043

## Robert W. Droll Landscape Architect, PS



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Site Planning
Environmental Design

Urban Design Land Planning Project Management



Consulting Engineers

612 Woodland Square Loop SE, Suite Lacey, Washington 98503

(360) 292-7230 Fax (360) 292-7231

# Project Record Drawings


PROJECT NO. .


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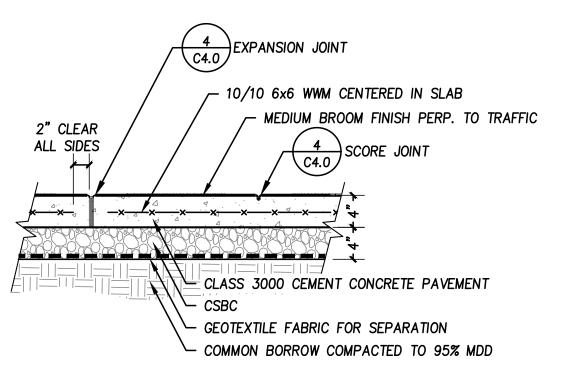
**Drainage Details** 


C3.1

Sheet 10 of 19



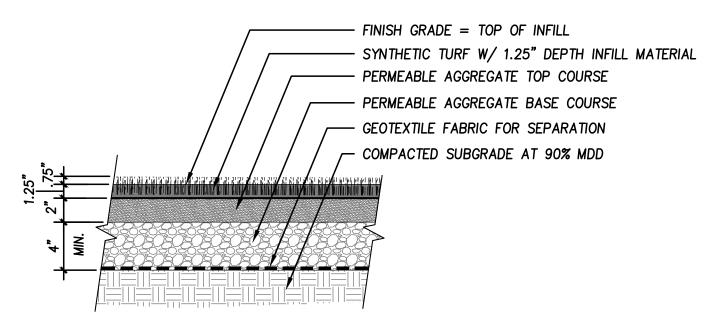

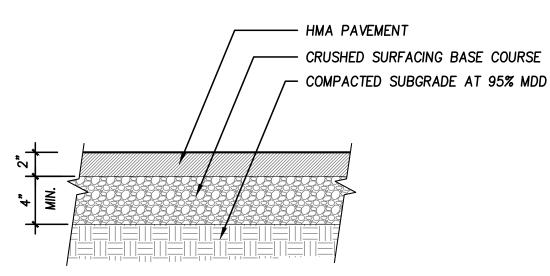

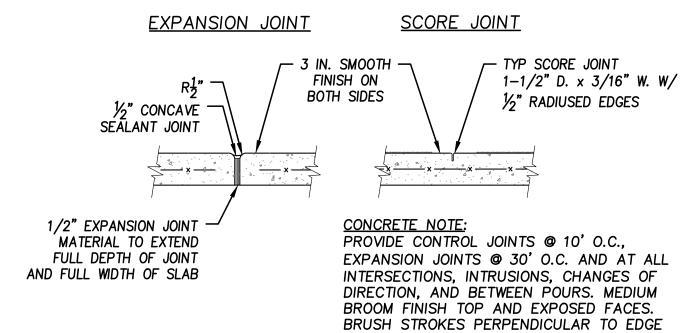

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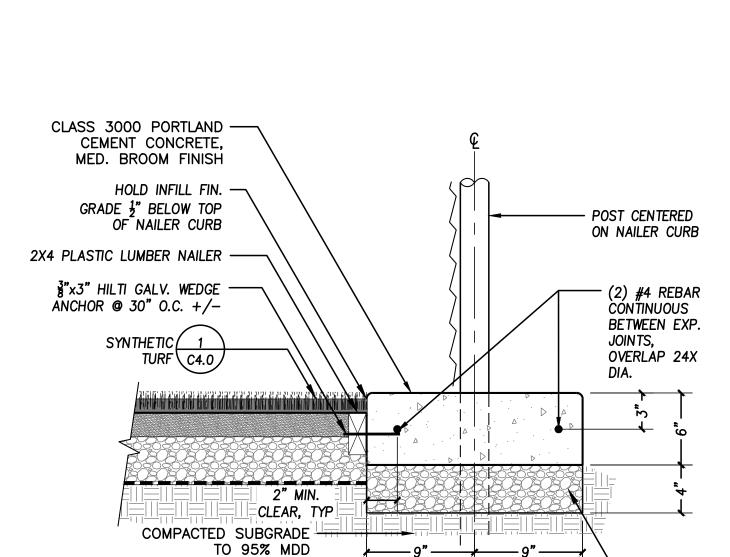
# Synthetic Turf C4.0 SCALE: 1½"=1'


2 Asphalt Paving


C4.0 SCALE: 1½"=1"

**Expansion Joint / Score Joint** 

C4.0 SCALE: 1½"=1'



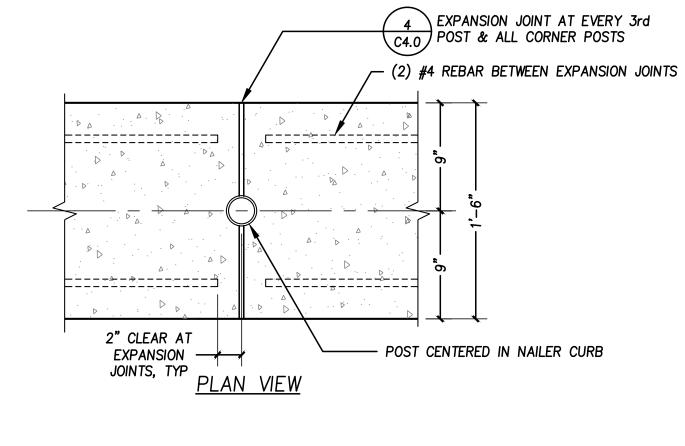

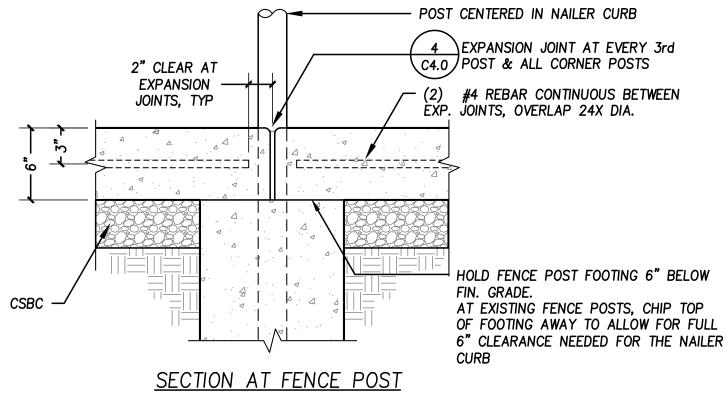

#### NOTES:


 POST FOOTING NOT SHOWN FOR CONVENIENCE. INSTALL ALL POSTS AND FOOTINGS AS PER DETAILS.

CROSS SECTION

2. PROVIDE SCORE JOINTS AT EACH POST LOCATED BETWEEN EXPANSION JOINTS

#### Cement Conc. Nailer Curb

C4.0 SCALE: 1½"=1'

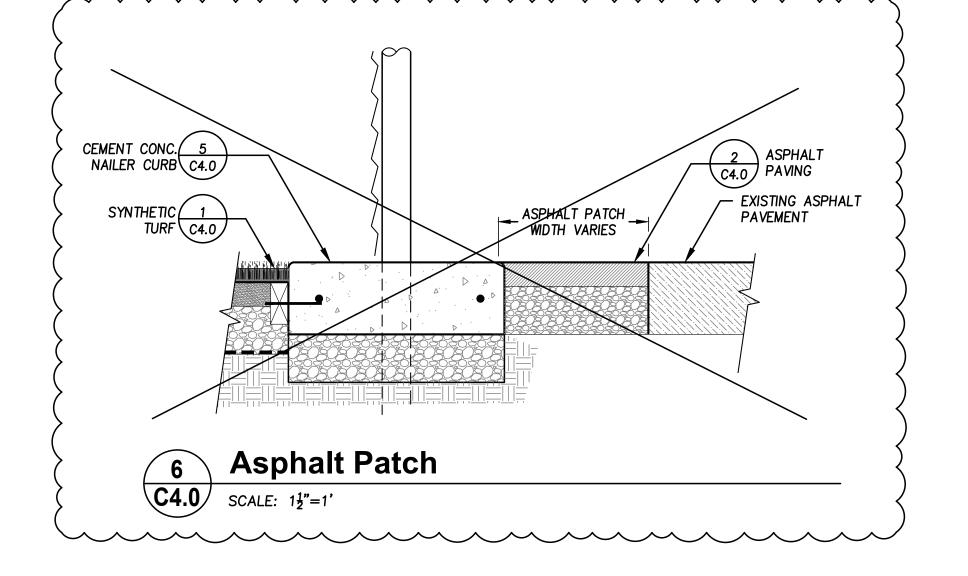

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# **Evergreen Playfield**

Н

22231 56th Ave W. Mountlake Terrace, WA 98043

#### Robert W. Droll



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(360) 456-3813

Urban Design Land Planning Project Management

Environmental Design



Project Record
Drawings

PROJECT NO. \_

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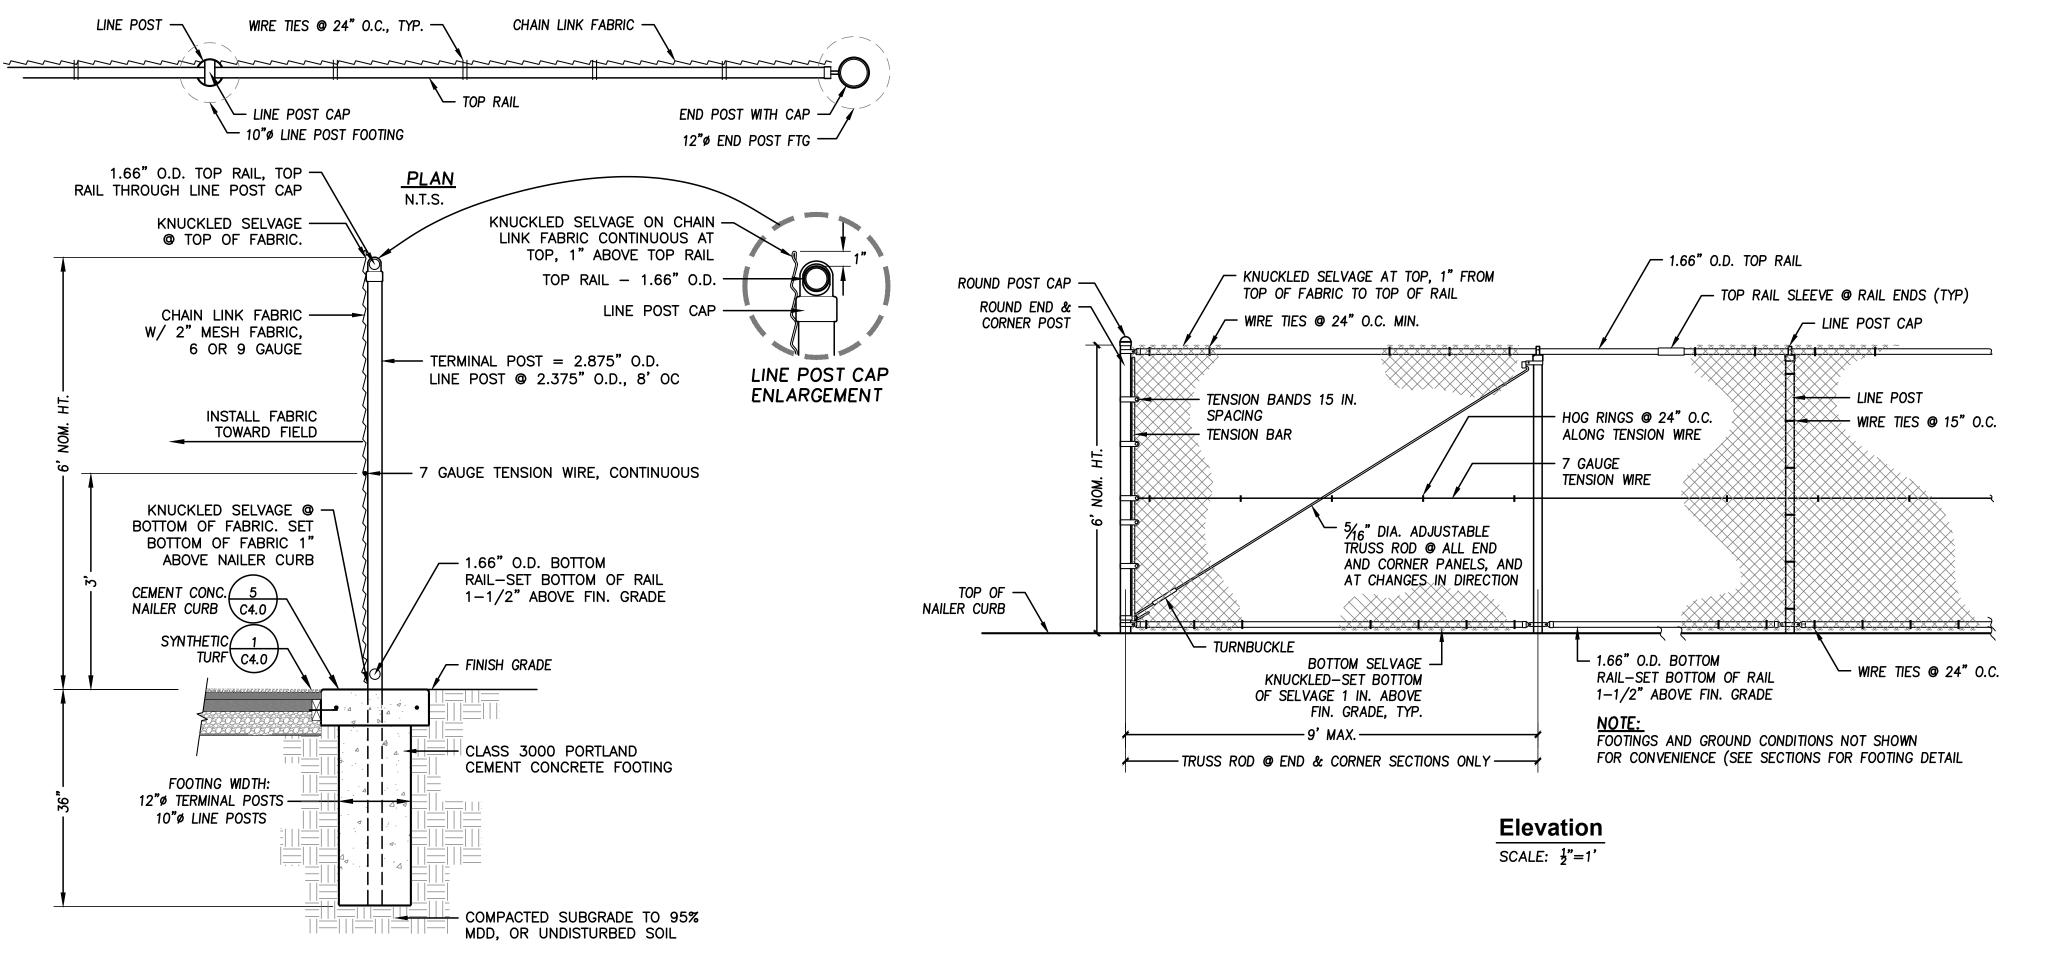
Site Details

DATE:

January 10, 2022

C4.0

Sheet \_11 of \_19



E

C

NOTE:

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FOR ALL FENCE MATERIALS ON SITE:


Н

- 1. C.L. FABRIC USED ON SITE SHALL
  BE FUSION—BONDED PVC COLOR
  BLACK.
- 2. POST, RAILS, FITTINGS, AND APPURTENANCES SHALL BE PAINTED BLACK.

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1 6' Chainlink Fence C4.1 SCALE: AS NOTED




Section

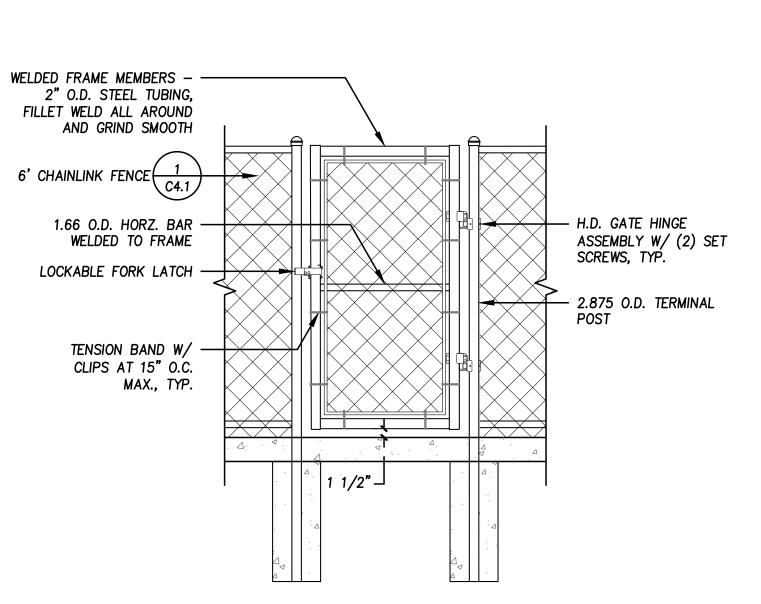
SCALE:  $\frac{3}{4}$ "=1"

6' Chainlink Gate

1) SCALE: ½"=1'

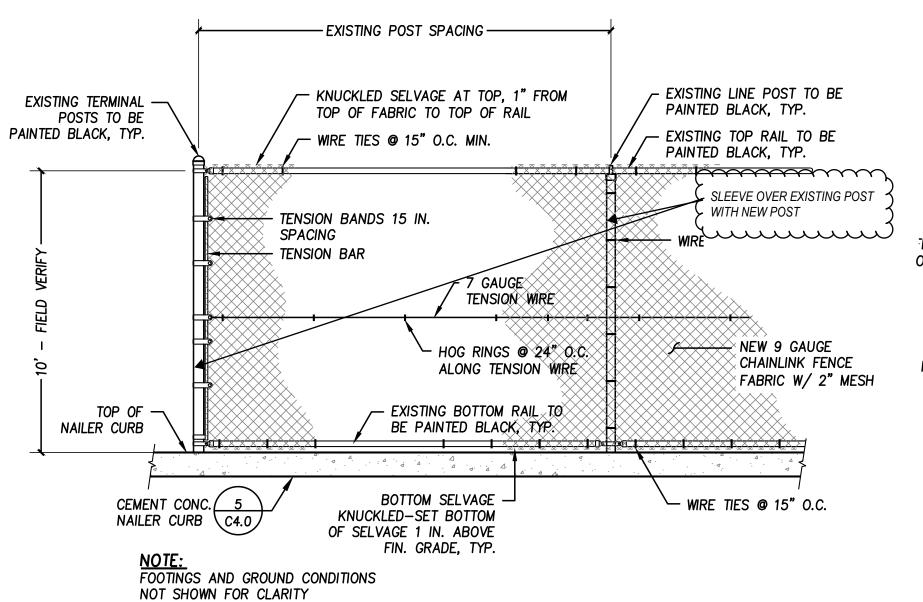

Refurbished Existing 10' Chainlink Fence
NOT TO SCALE

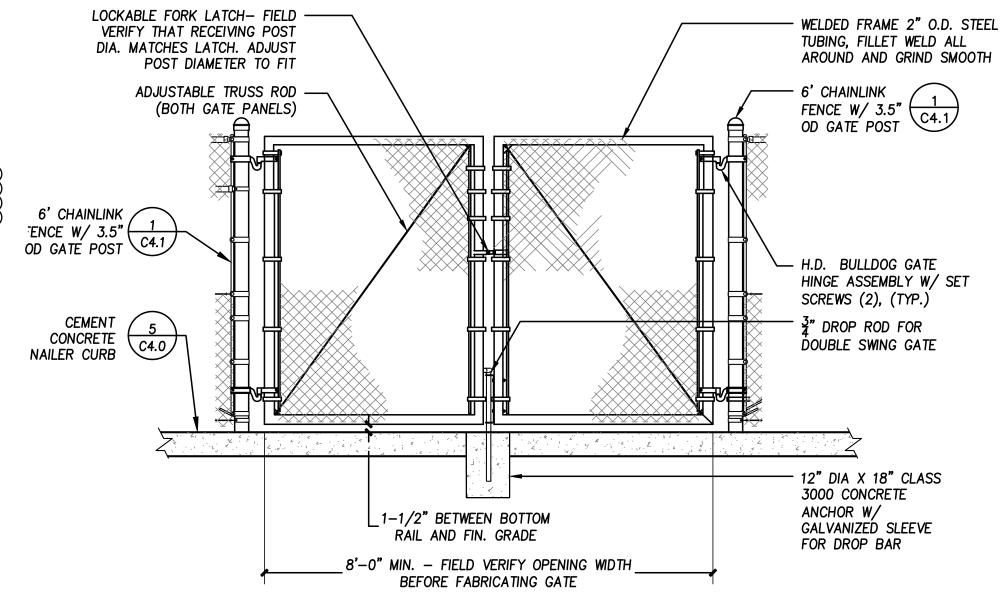

8' Wide Double Swing Gate
C4.1 NOT TO SCALE



# **Evergreen Playfield**

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# Project Record Drawings

PROJECT NO.

DESIGNED BY BD, DC, RT
DRAWN BY RT, PV
CHECKED BY BD

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DATE CHANGE


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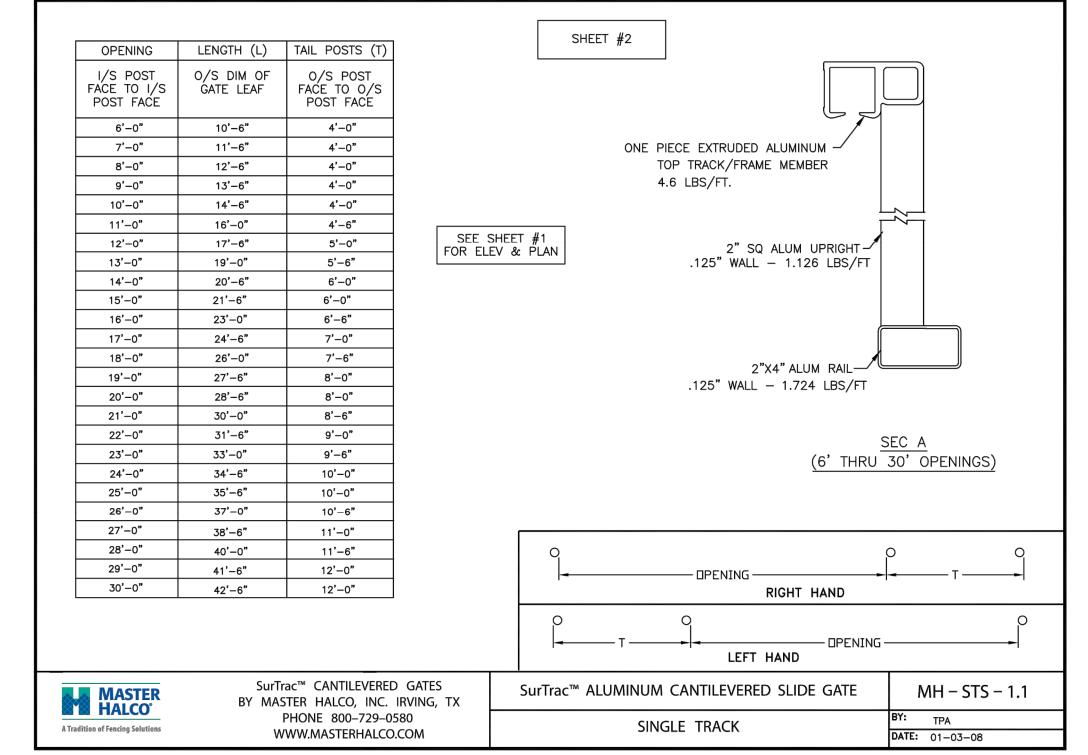
January 10, 2022

DATE:


C4.1


Sheet 12 of 19



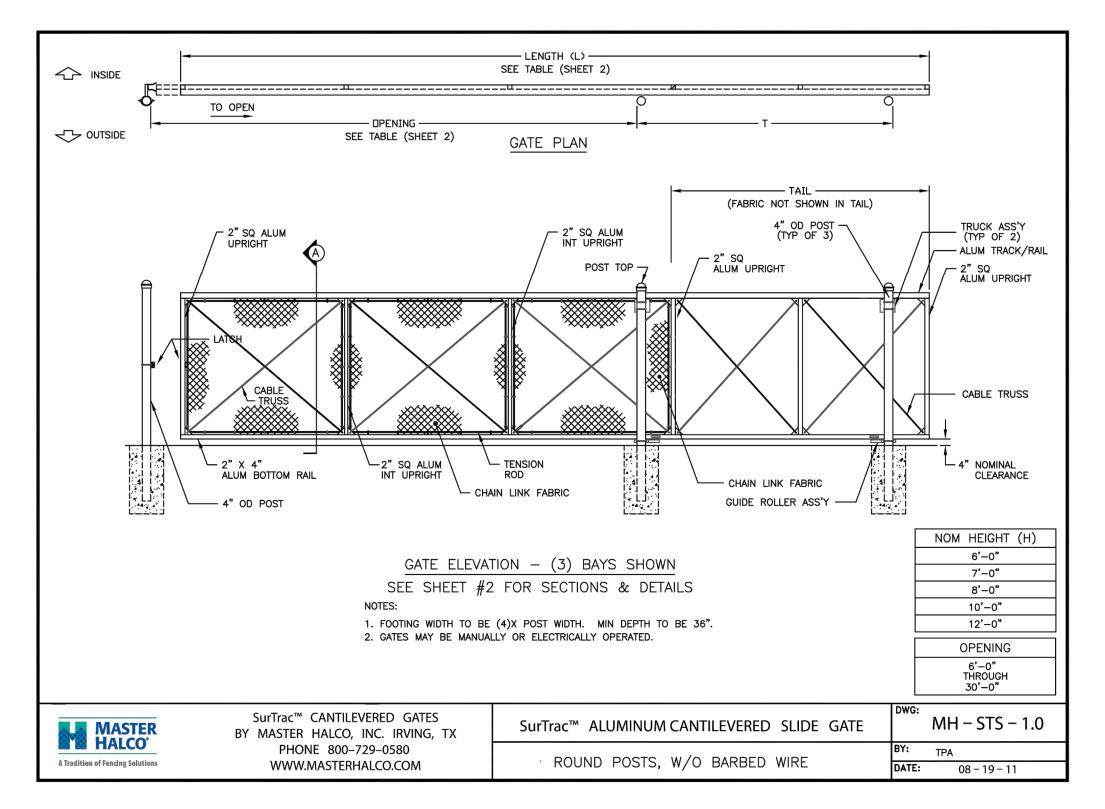

G

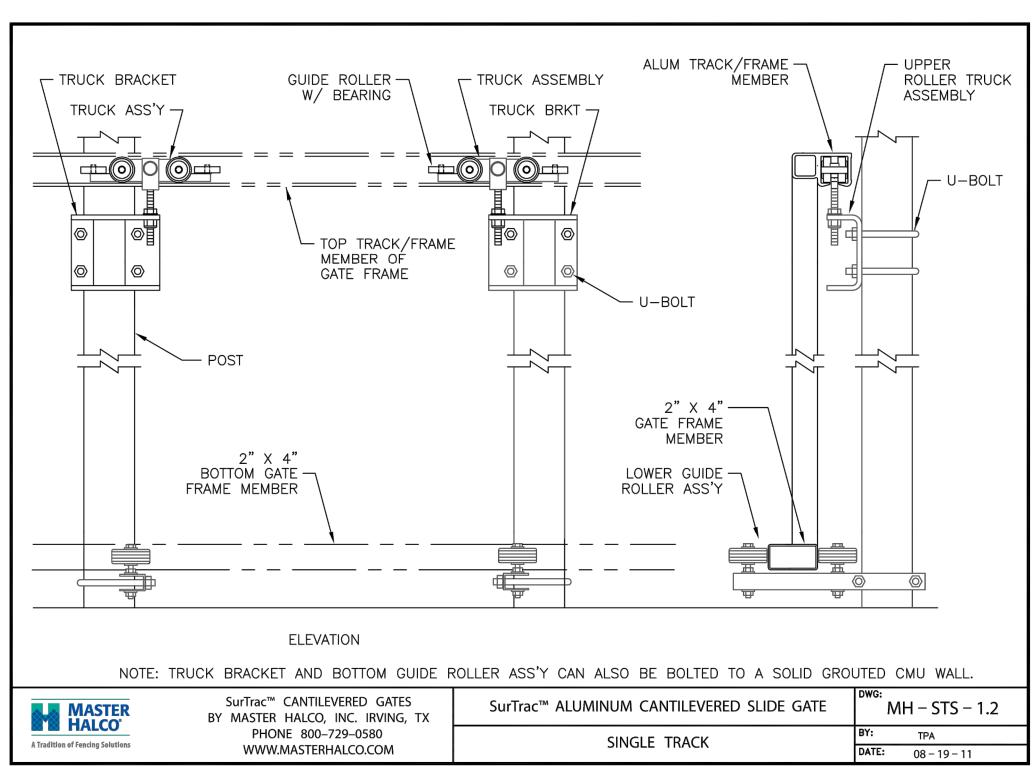

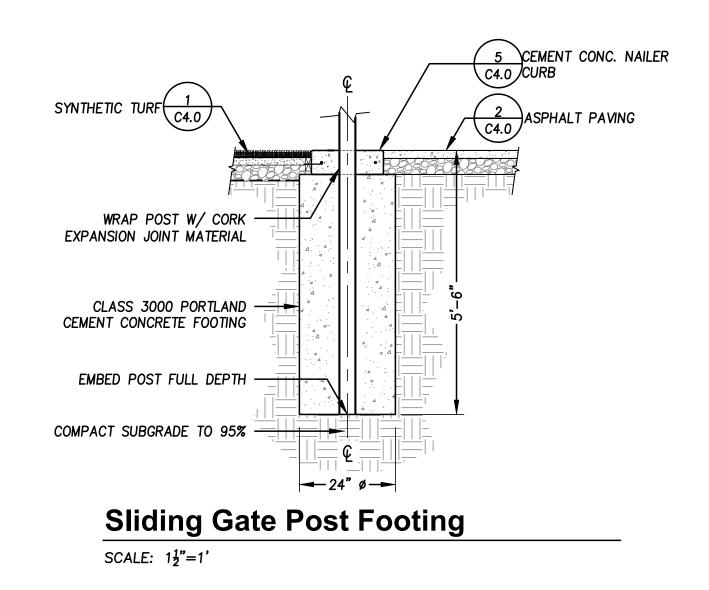

D

- 1. GATE OPENING SHALL BE 12'-0"WIDE
  2. ALL GATE COMPONENTS AND FRAME SHALL BE BLACK
  3. GATE WILL BE MANUALLY OPERATED

**Sliding Gate** C4.2 SCALE: NTS

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# Evergreen Playfield

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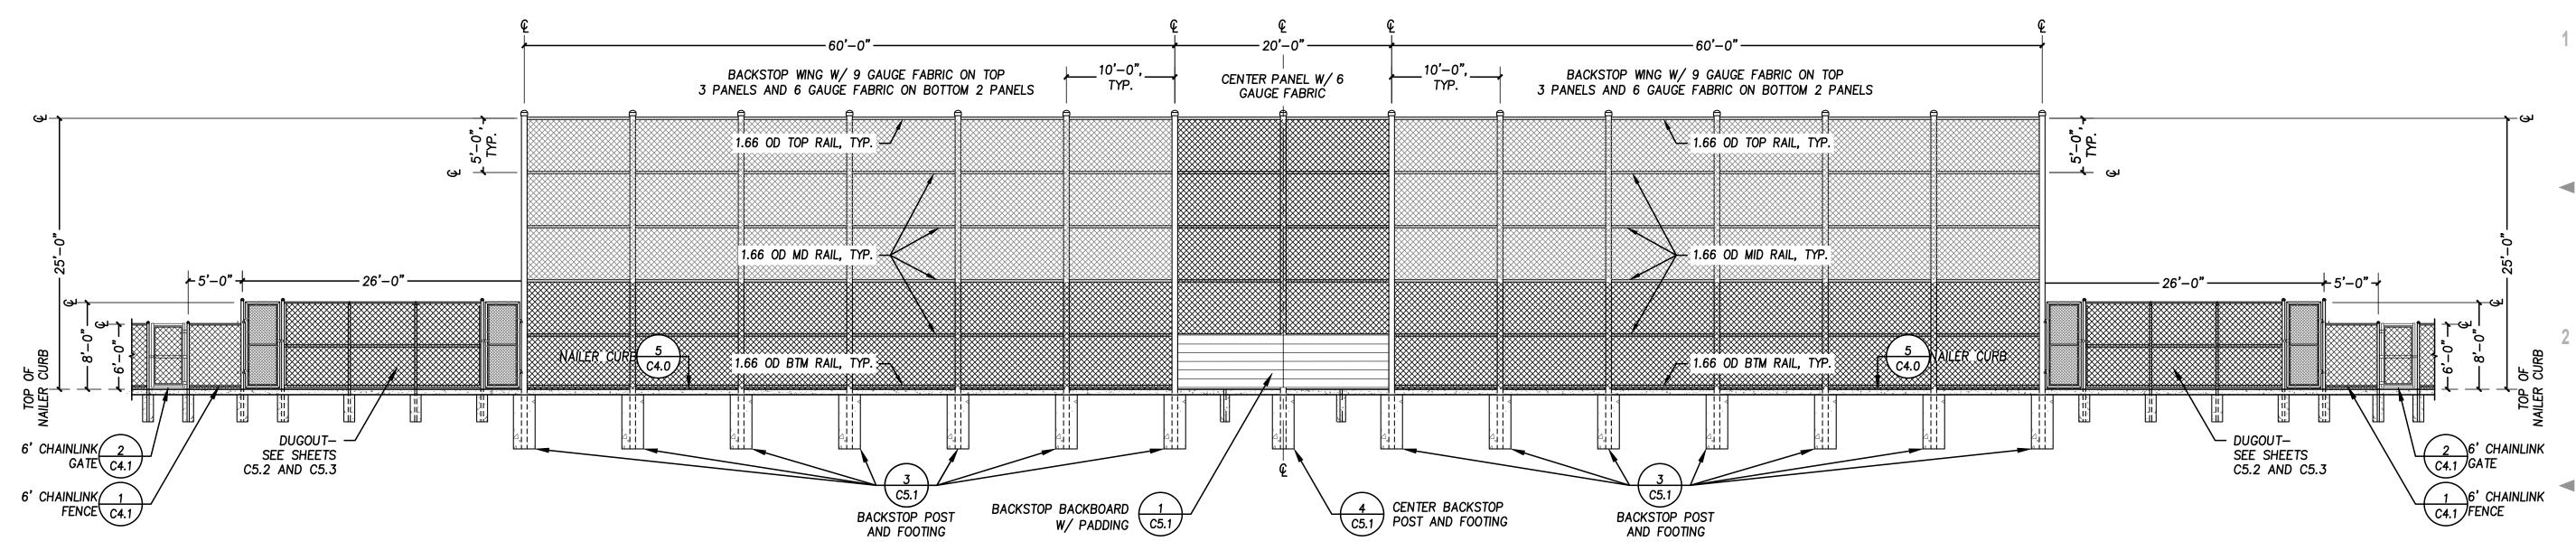
#### Project Record Drawings

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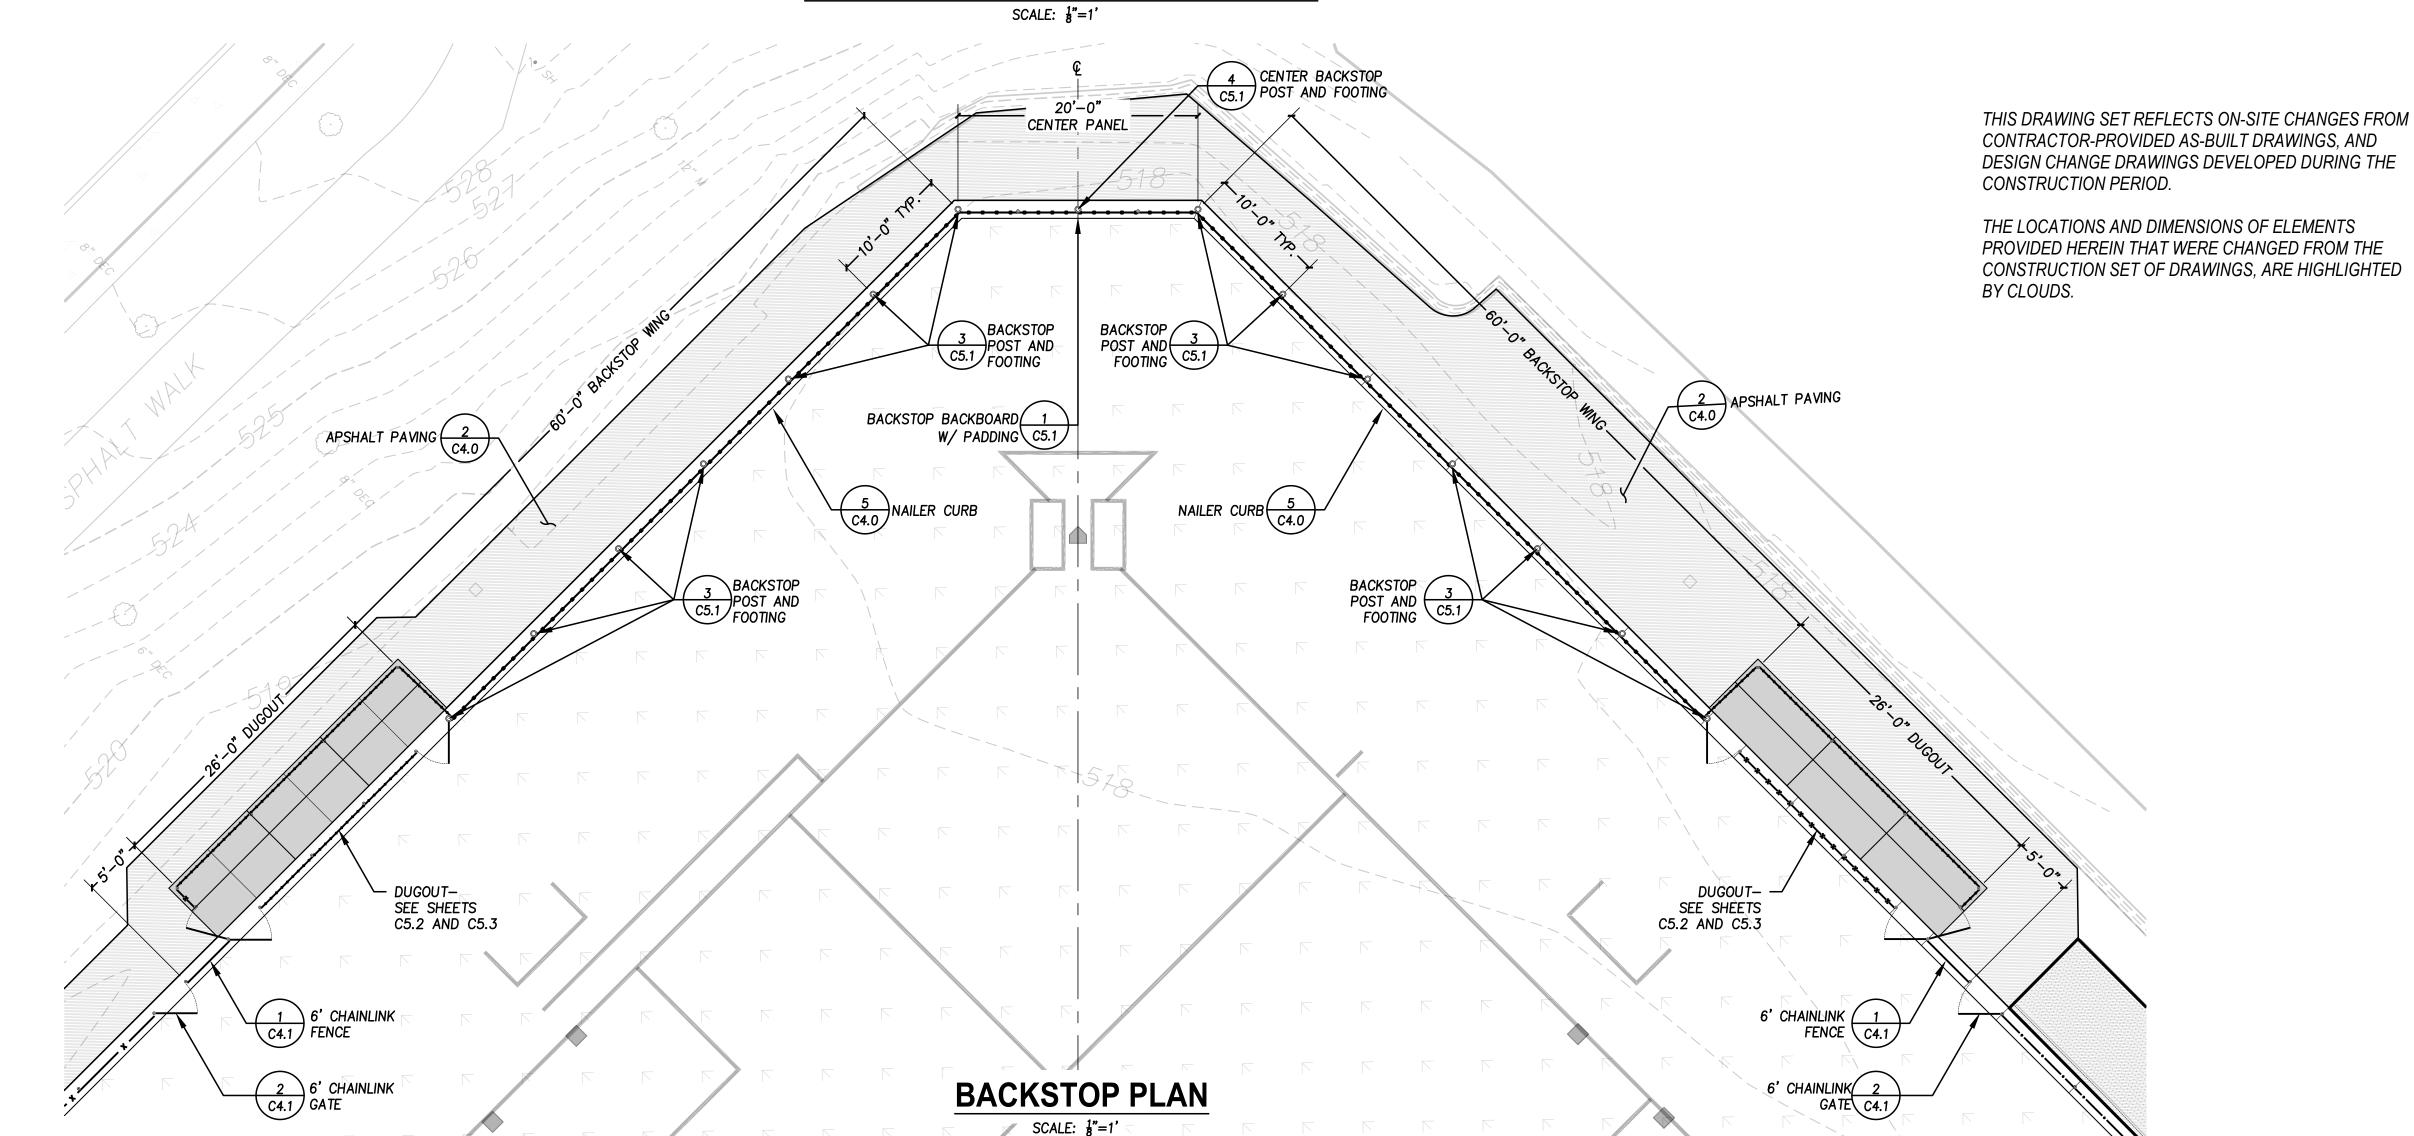
**Site Details** 

DATE: January 10, 2022

Sheet 13 of 19



#### **BACKSTOP FIELD SIDE ELEVATION**



# **Evergreen Playfield**

22231 56th Ave W. Mountlake Terrace, WA 98043

## Robert W. Droll Landscape Architect, PS



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# Project Record Drawings

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DRAWN BY \_\_\_\_\_RT, PV
CHECKED BY \_\_\_\_\_BD

PROJECT NO.

RE VISION
DATE CHANGE

DATE: January 10, 2022

# Backstop Plan & Elevation

C5.0

Sheet <u>14</u> of <u>19</u>


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### 1 Backstop Backboard

**C5.1** SCALE: ¼"=1"



G

**∀** Backstop Backboard Section

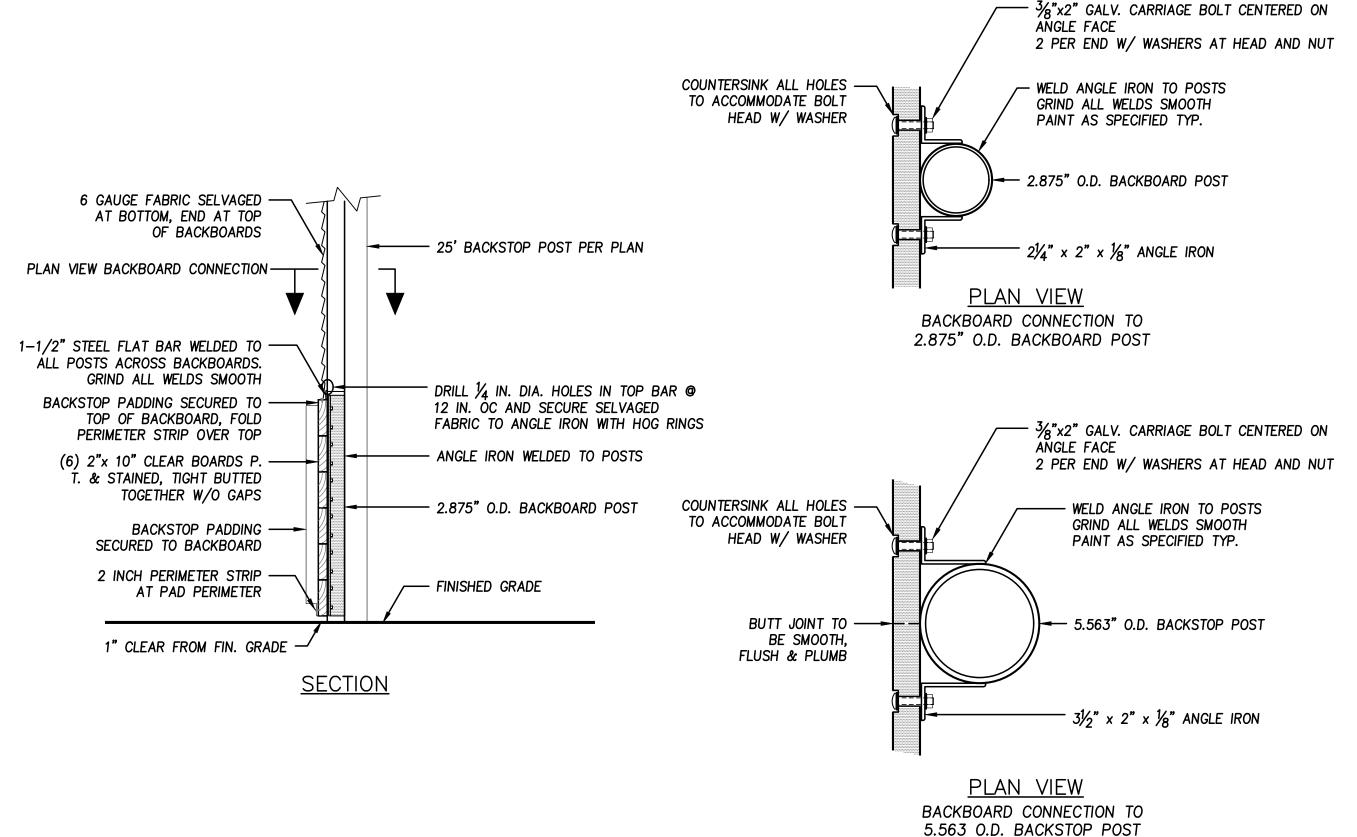SCALE: NTS

E

FIELD SIDE FIELD SIDE CHAIN LINK FABRIC ON CHAIN LINK FABRIC ON FIELD SIDE OF POST. FIELD SIDE OF POST, 25' TALL (ABOVE FIN. GRADE) 25' TALL (ABOVE FIN. GRADE) FULL HEIGHT OF POST FULL HEIGHT OF POST 5.563" O.D. SCH 40 GALV. 5.563" O.D. SCH 80 GALV. FENCE FABRIC FENCE FABRIC STEEL BACKSTOP POST STEEL BACKSTOP POST (KNUCKLED SELVAGE) (KNUCKLED SELVAGE) BOTTOM RAIL 2" ABOVE BOTTOM RAIL 2" ABOVE END AT FIN. GRADE, END AT FIN. GRADE, MAX. 1" ABOVE FIN. FIN. GRADE MAX. 1" ABOVE FIN. FIN. GRADE 5 CEMENT CONC. NAILER 5 CEMENT CONC. NAILER C4.0 CURB C4.0 CURB SYNTHETIC TURF (C4.0) SYNTHETIC TURF (c4.0) 3 CEMENT CONCETE 3 CEMENT CONCETE C4.0 PAVING C4.0 PAVING WRAP POST W/ CORK WRAP POST W/ CORK EXPANSION JOINT MATERIAL EXPANSION JOINT MATERIAL CLASS 3000 PORTLAND -CLASS 3000 PORTLAND -CEMENT CONCRETE CEMENT CONCRETE **FOOTING** COMPACT SUBGRADE COMPACT SUBGRADE EMBED POST EMBED POST TO 95% TO 95% FULL DEPTH FULL DEPTH **─**24" Ø <del>-</del>

Backstop Post and Footing

C5.1 SCALE: ½"=1"

#### Center Backstop Post and Footing

C5.1 SCALE: ½"=1"

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# **Evergreen Playfield**

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# Project Record Drawings

PROJECT NO. 19068

DRAWING \_\_\_\_\_\_\_

DESIGNED BY \_\_\_\_\_\_BD, DC, RT
DRAWN BY \_\_\_\_\_\_RT, PV
CHECKED BY \_\_\_\_\_\_BD


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DATE \_\_\_\_\_CHANGE


DATE: January 10, 2022

**Backstop Details** 

C5.1

Sheet 15 of 19

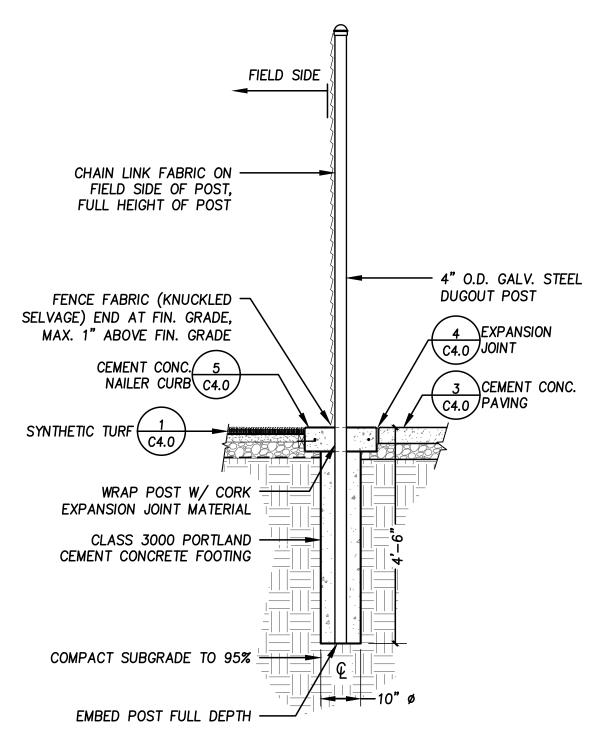


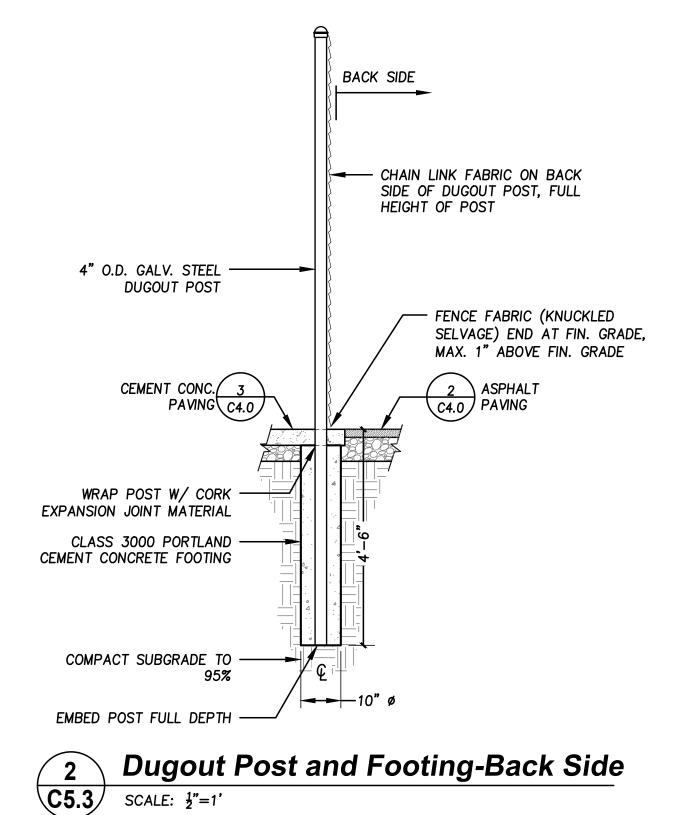

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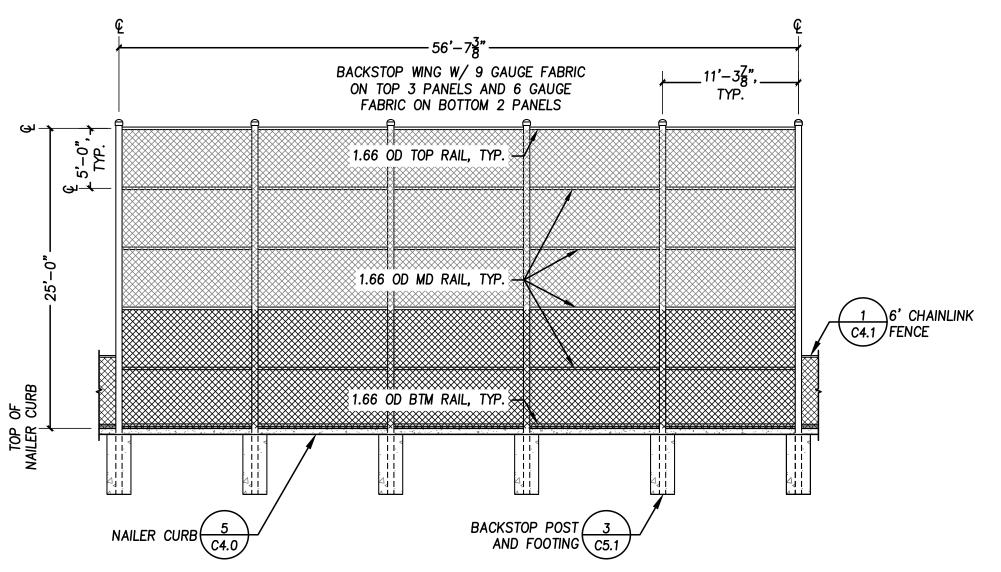
SCALE: ½"=1"



G

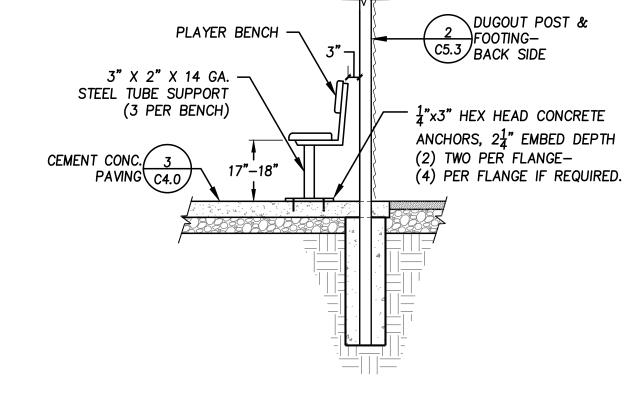

**Dugout Post and Footing-Field Side** C5.3 SCALE: ½"=1"



Tee Ball Backstop C5.3 SCALE: 1"=1"

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#### Project Record Drawings

PROJECT NO.


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#### **Dugout and Backstop Details**

DATE: January 10, 2022

C5.3

Sheet <u>17</u> of <u>19</u>

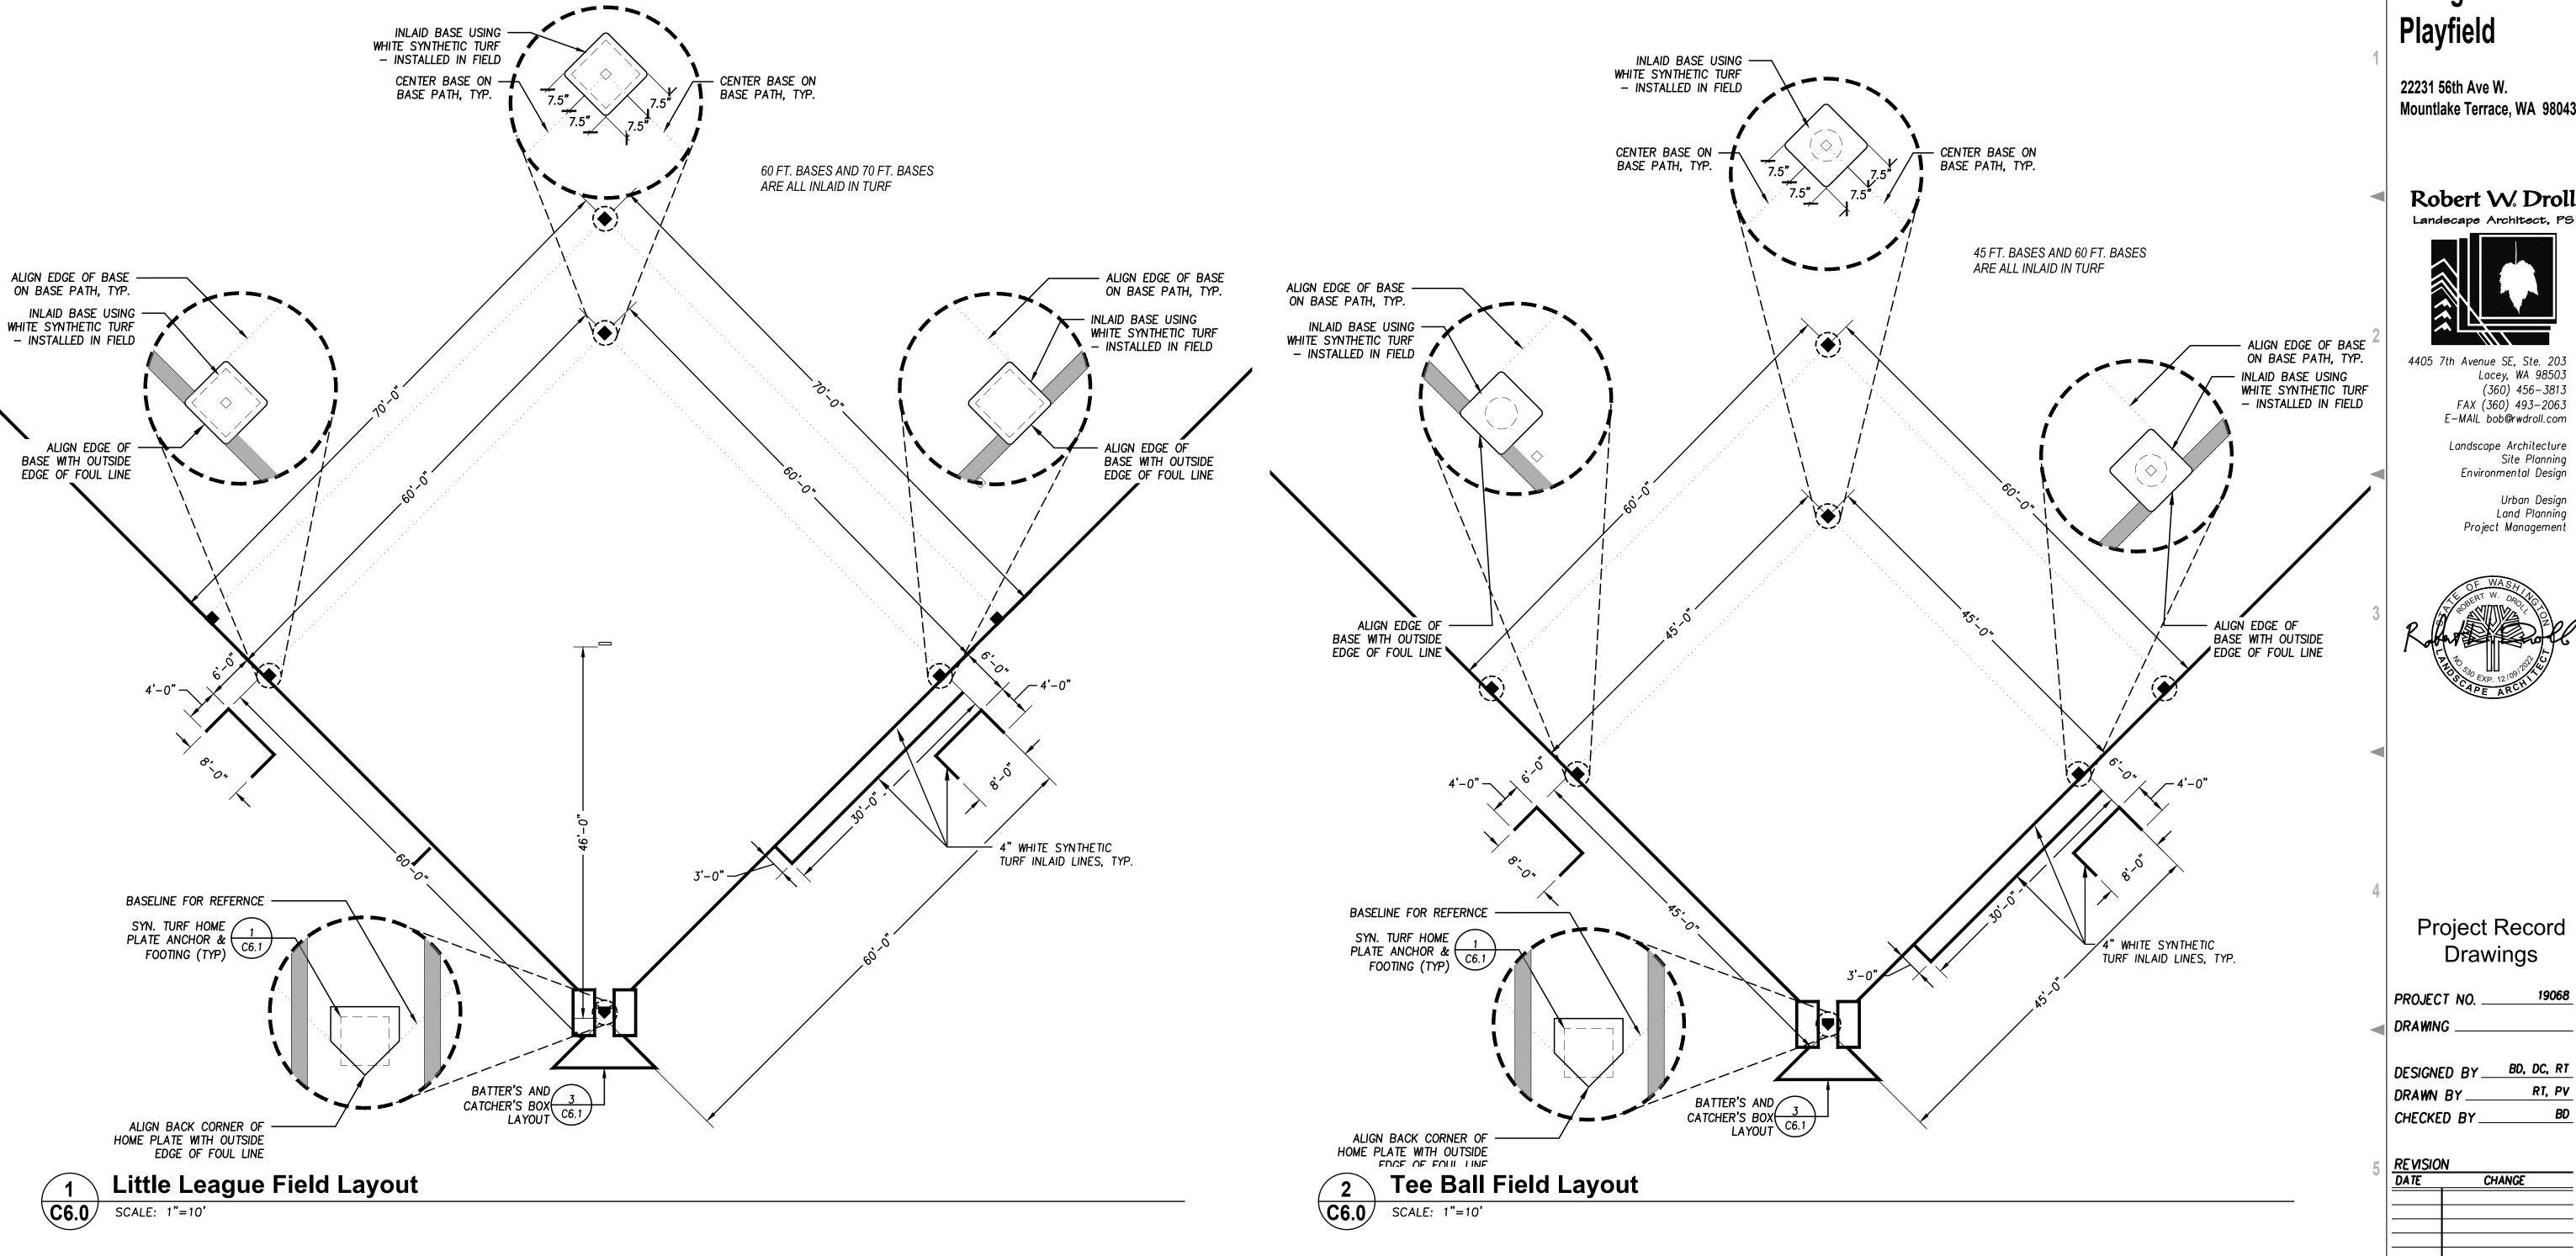

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## Evergreen Playfield

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#### Project Record Drawings

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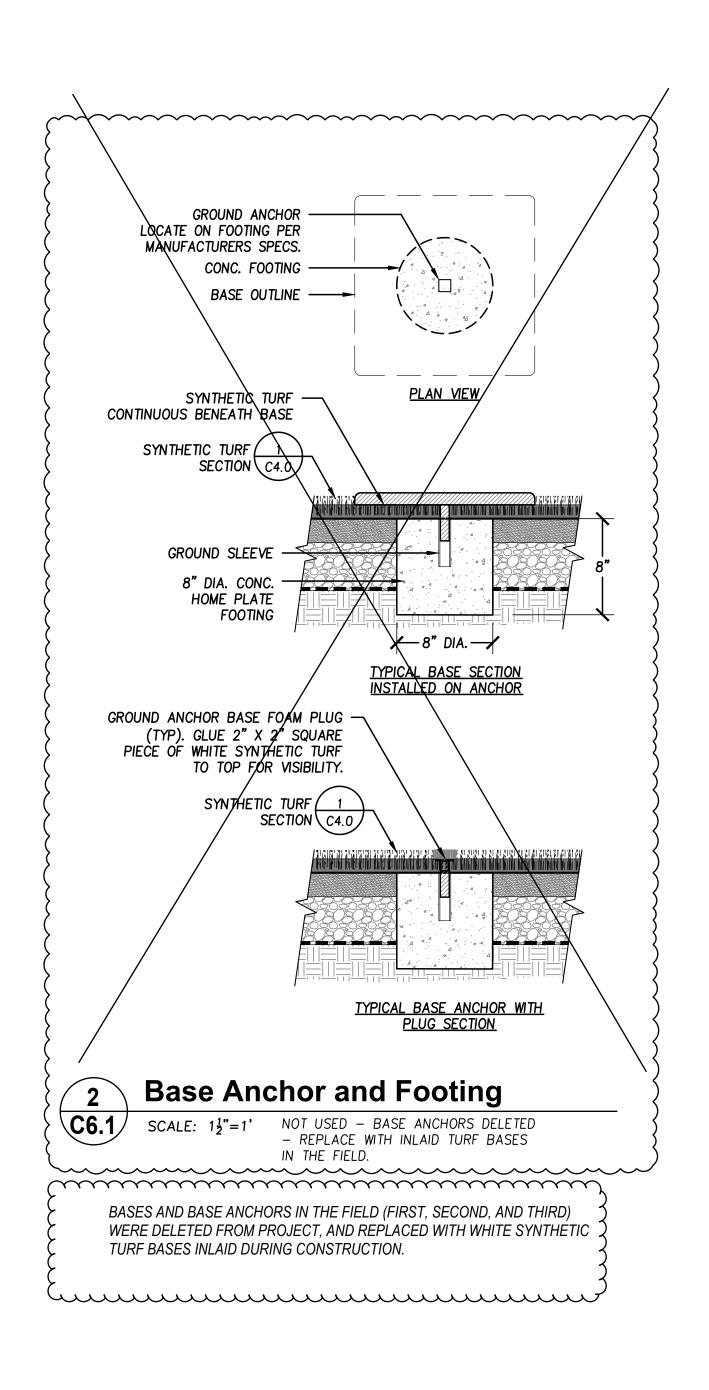
#### **Sportsfield Layout Plans**

**C6.0** 


Sheet <u>18</u> of <u>19</u>

**Home Plate Anchor and Footing** 

**C6.1** SCALE: 1½"=1'



D

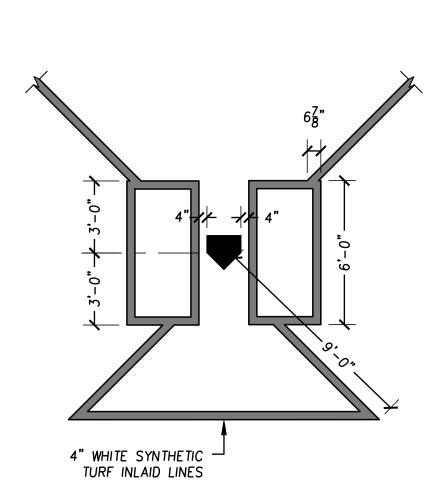

**Batter's and Catcher's Box Layout** 

**C6.1** SCALE: 1½"=1'

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> Sportsfield **Details**

Sheet <u>19</u> of <u>19</u>